
ALPENA COUNTY, MICHIGAN

1998 WATER TREATMENT PLANT IMPROVEMENTS CHEMICAL AND STORAGE BUILDING


NOVEMBER, 1998


BUILDING CODE INFORM	IATION
CONSTRUCTION TYPE	3B
OCCUPANCY	F-2
ALLOWABLE FLOOR AREA	14,400 S.F.
ACTUAL FLOOR AREA	2,331 S.F.

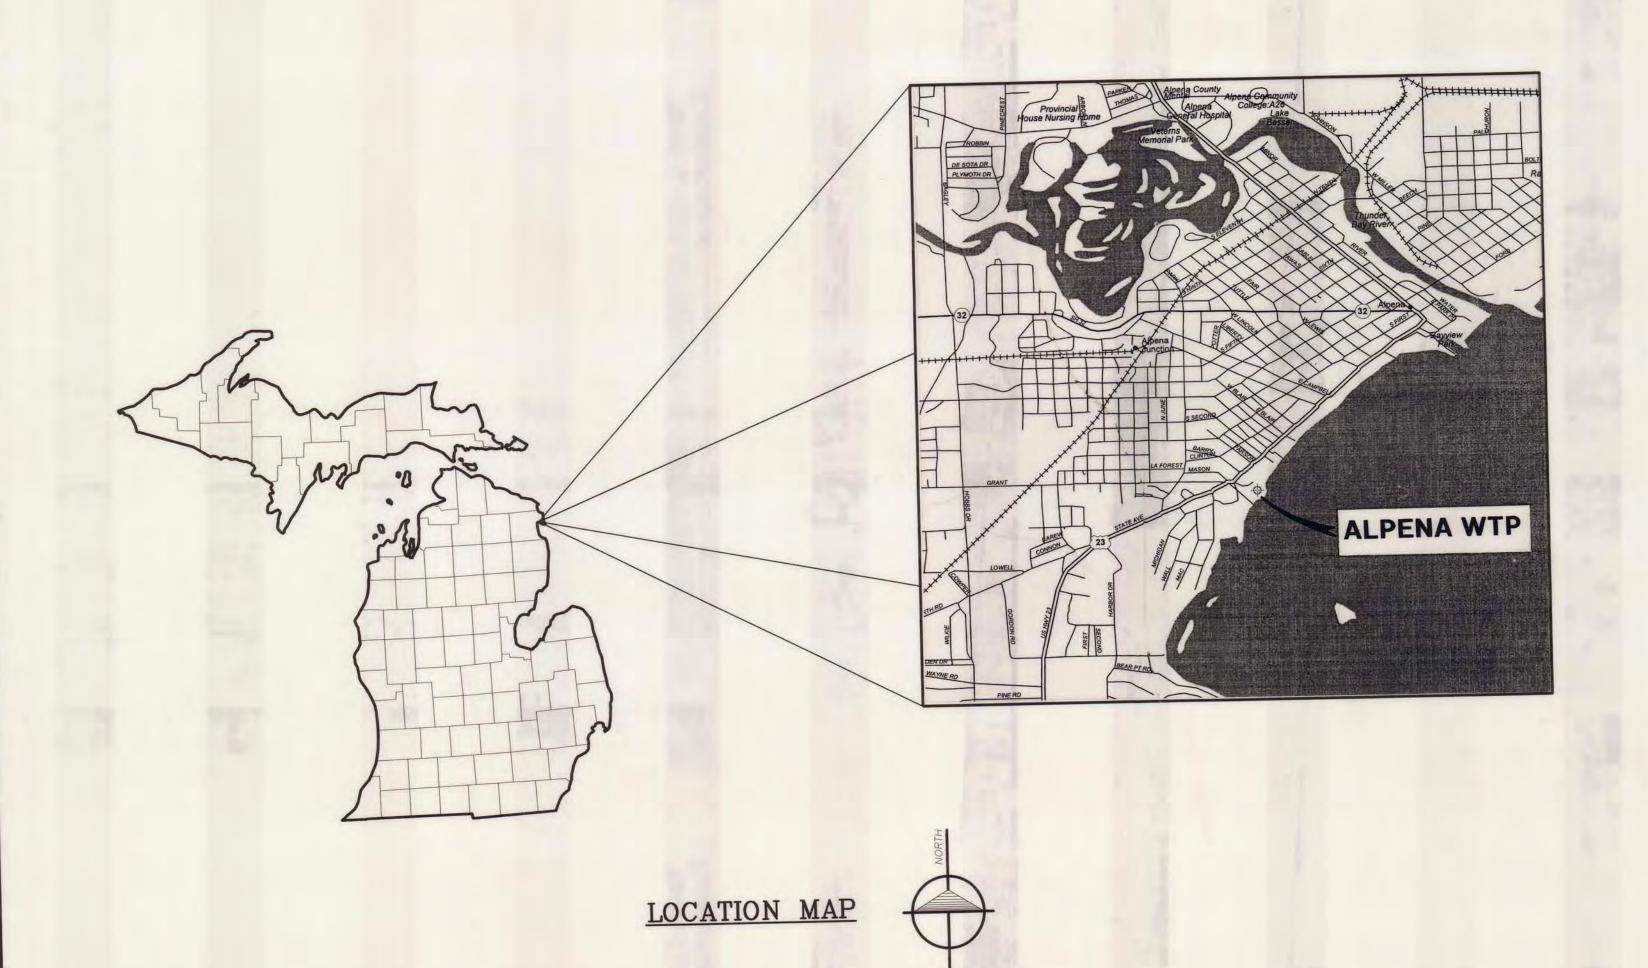



SHT. NO.	DRAWING INDEX
_	COVER SHEET
C1	CHEMICAL AND STORAGE BLDG. SITE PLAN w/DEMOLITION PLAN
C2	STANDARD DETAILS
A1	CHEMICAL AND STORAGE BLDG. PLAN AND ELEVATION
A2	CHEMICAL AND STORAGE BLDG. EXTERIOR ELEVATIONS
A3	CHEMICAL AND STORAGE BLDG. WALL SECTIONS
A4	CHEMICAL AND STORAGE BLDG. SCHEDULES AND DETAILS
S1	CHEMICAL AND STORAGE BLDG. FOUNDATION PLAN & DETAILS
S2	CHEMICAL AND STORAGE BLDG. ROOF FRAMING PLAN & DETAILS
S3	MISC. STRUCTURAL DETAILS
M1	CHEMICAL AND STORAGE BUILDING PLAN CHEMICAL FEED PIPING LAYOUT
M2	SODIUM HYPOCHLORITE SCHEMATIC LAYOUT
МЗ	CHEMICAL FEED ROOM PLANS
H1	CHEMICAL AND STORAGE BLDG. HVAC PLAN
E1	ELECTRICAL LEGEND
E2	ELECTRICAL SITE PLAN
E3	CHEMICAL AND STORAGE BUILDING ELECTRICAL PLAN
E4	CHEMICAL AND STORAGE BUILDING LIGHTING PLAN
E5	CHEMICAL FEED ROOM ELECTRICAL PLAN




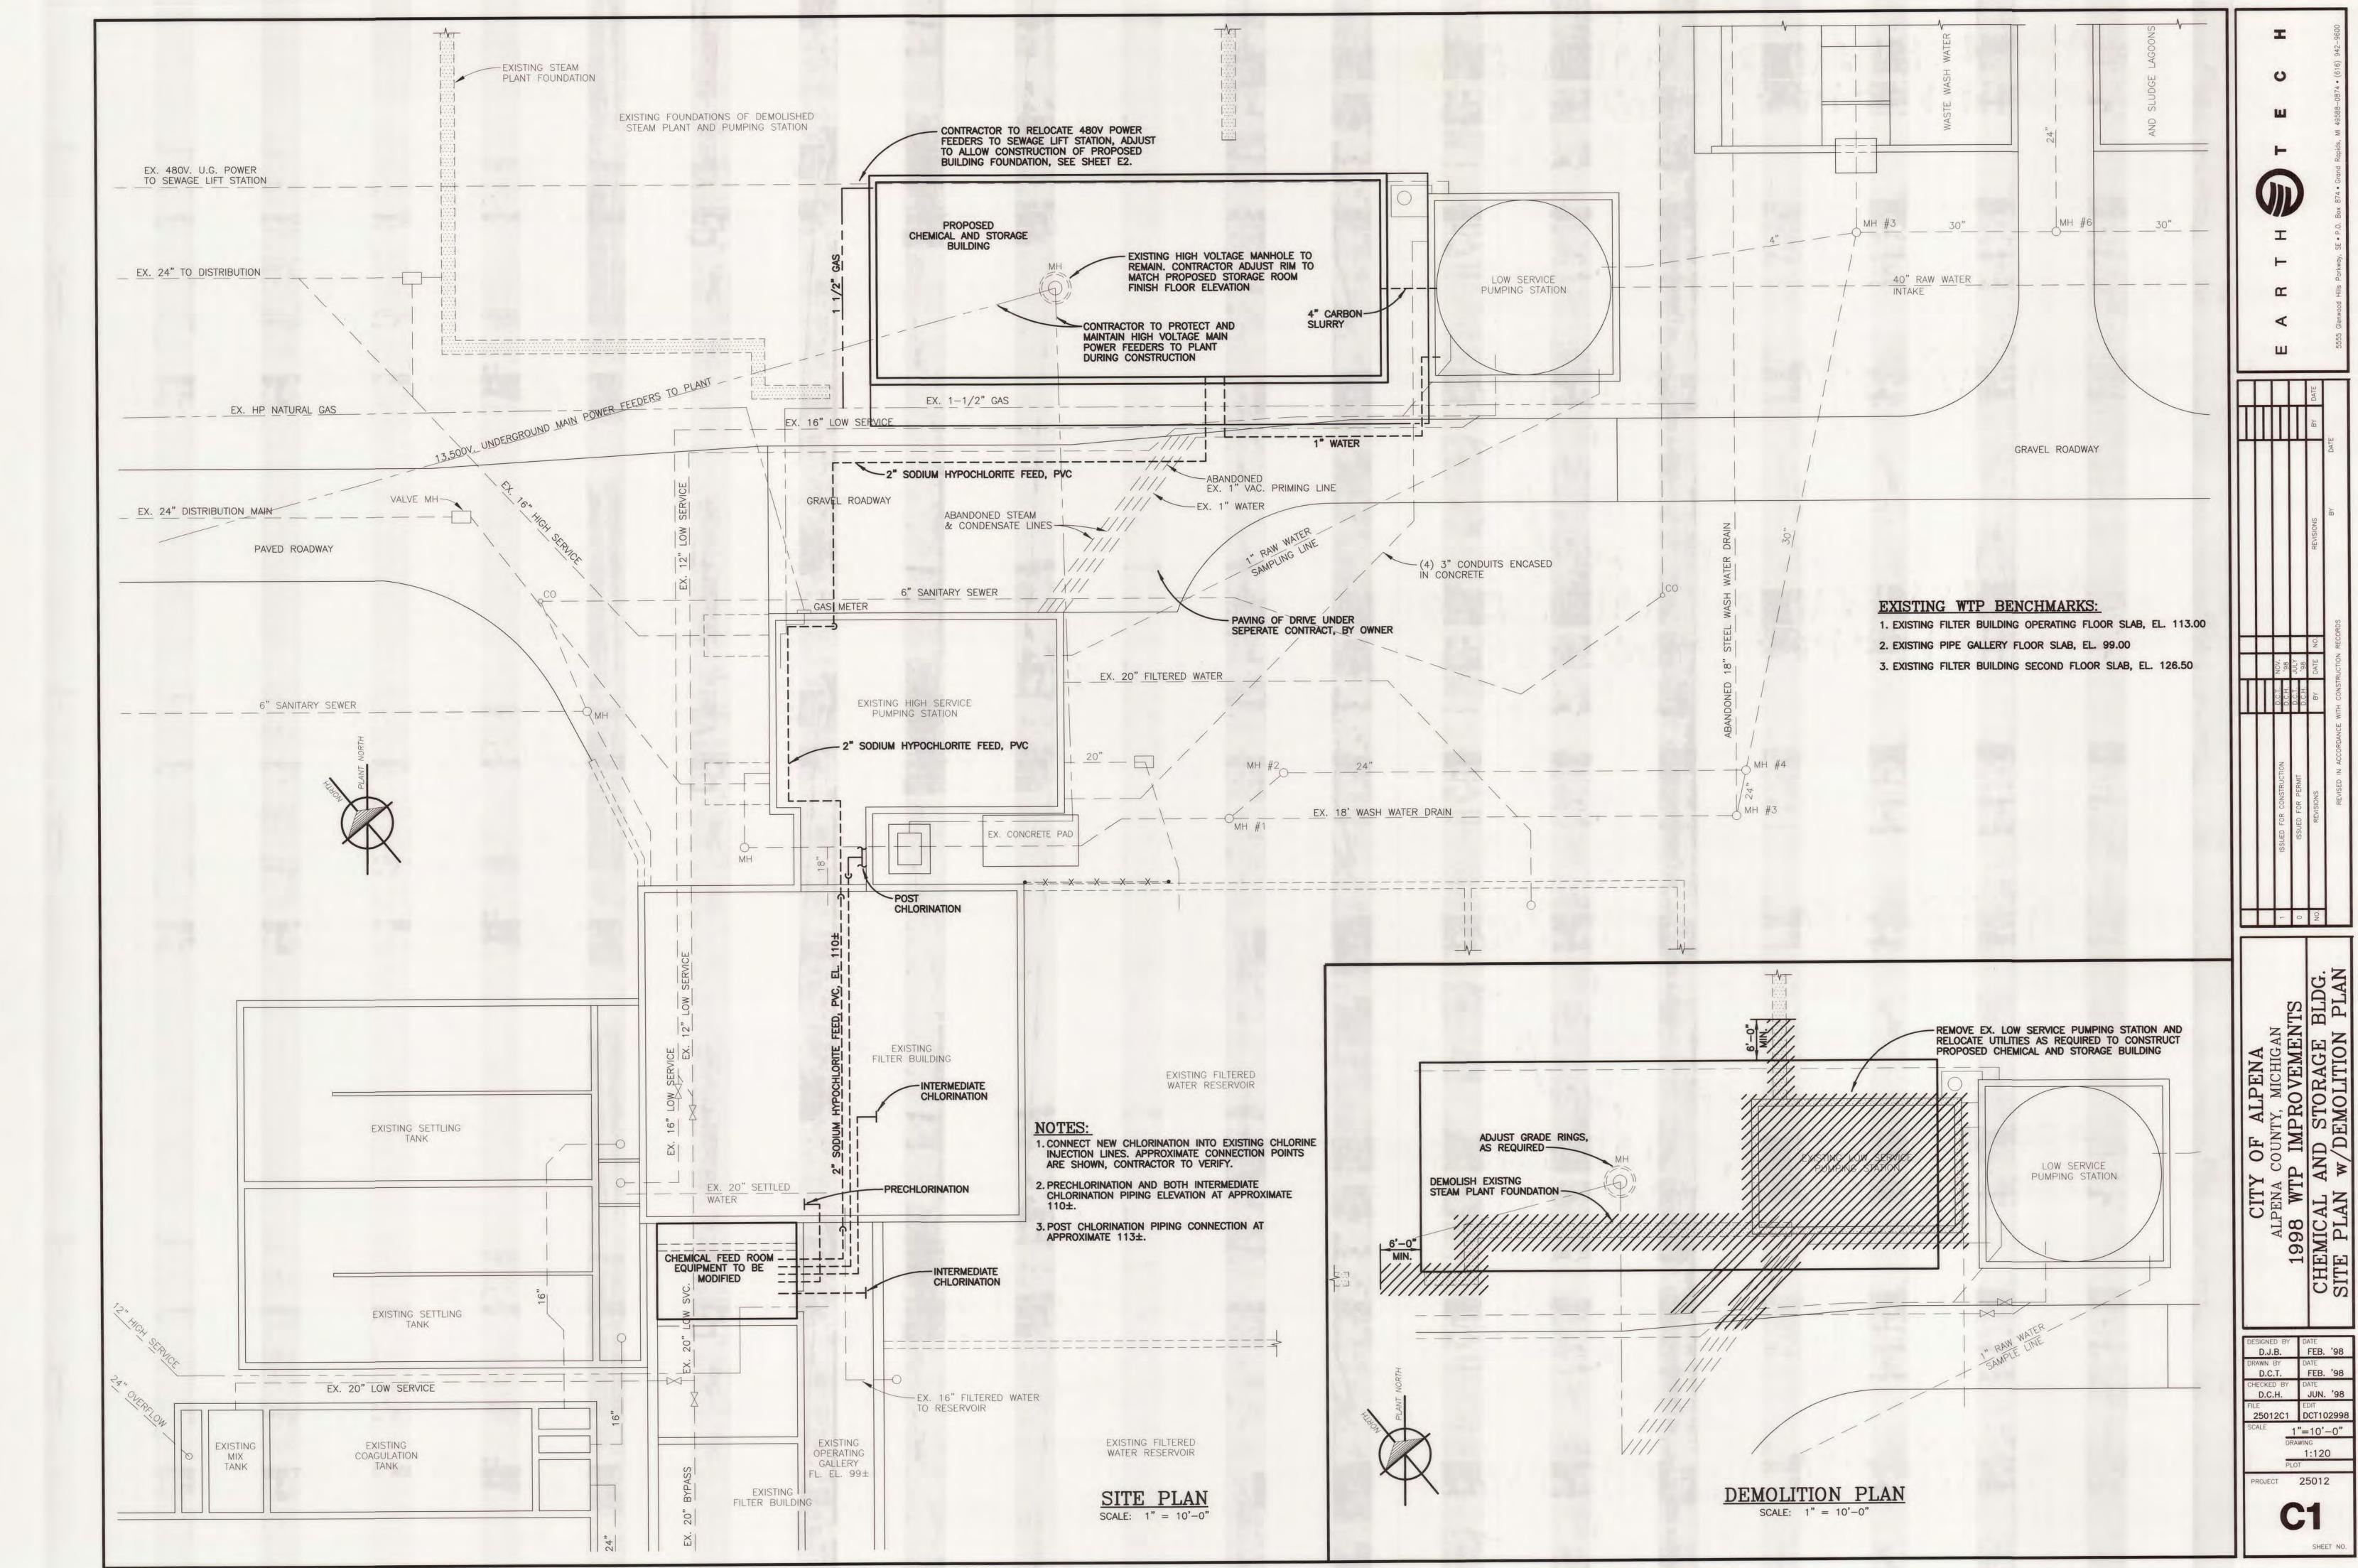


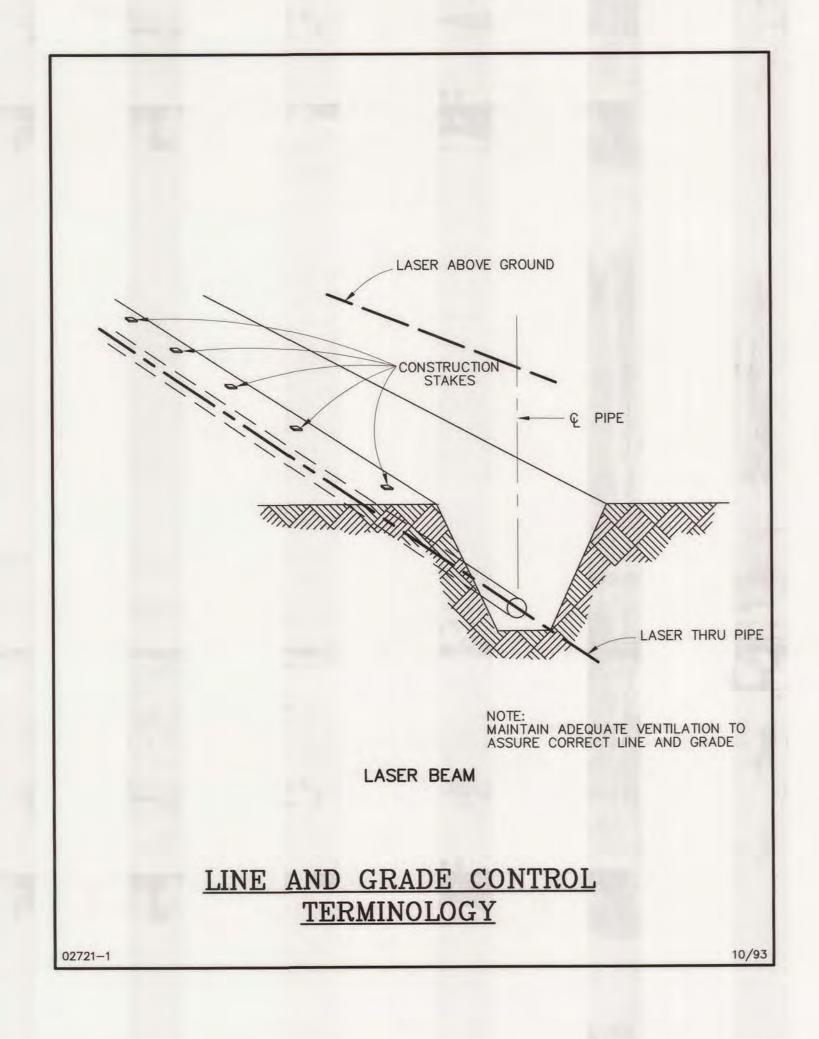

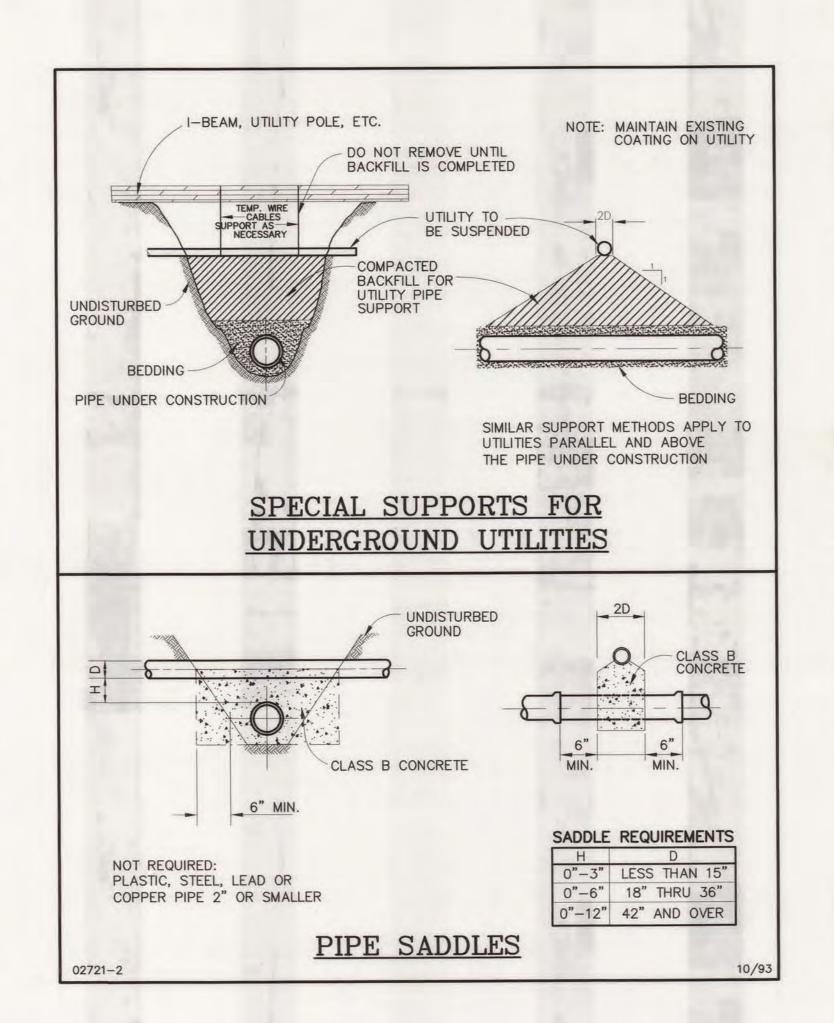

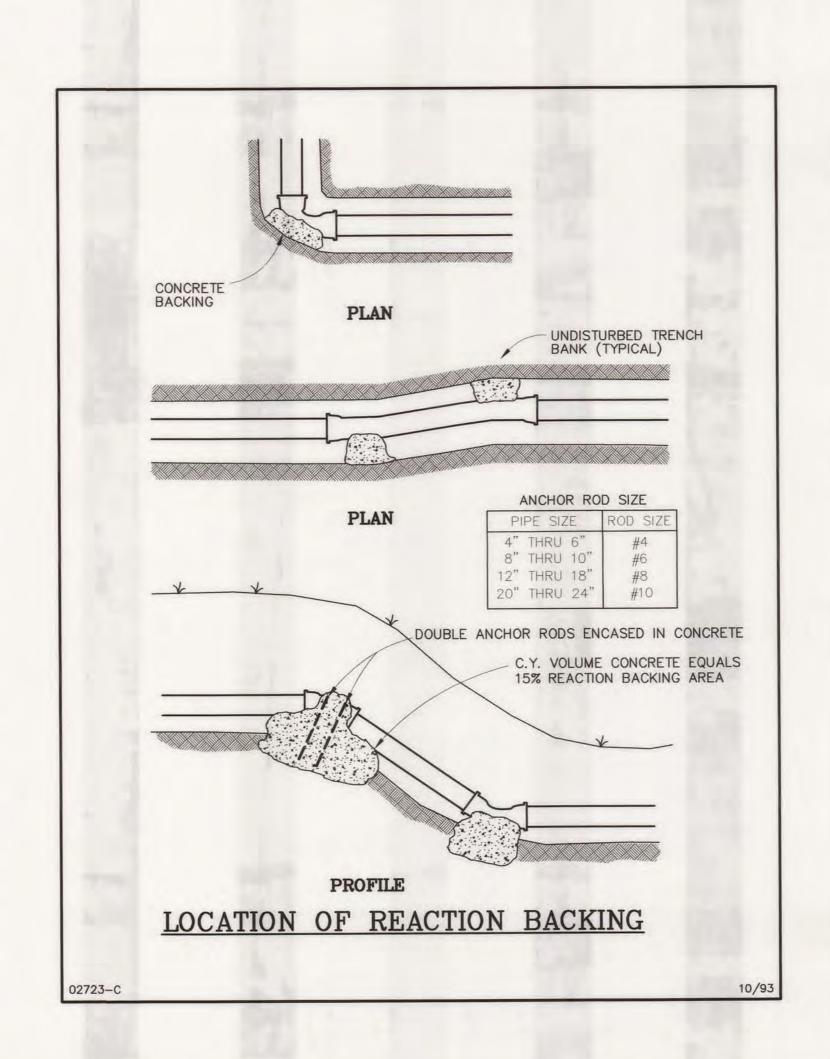

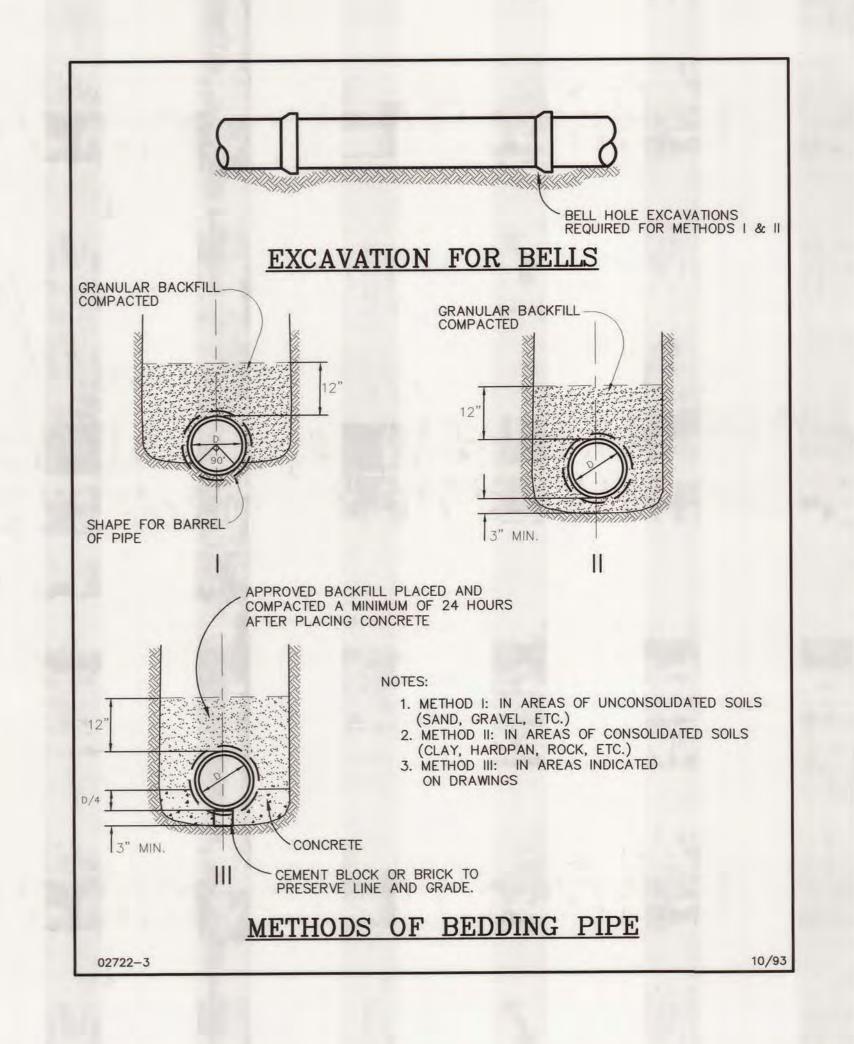

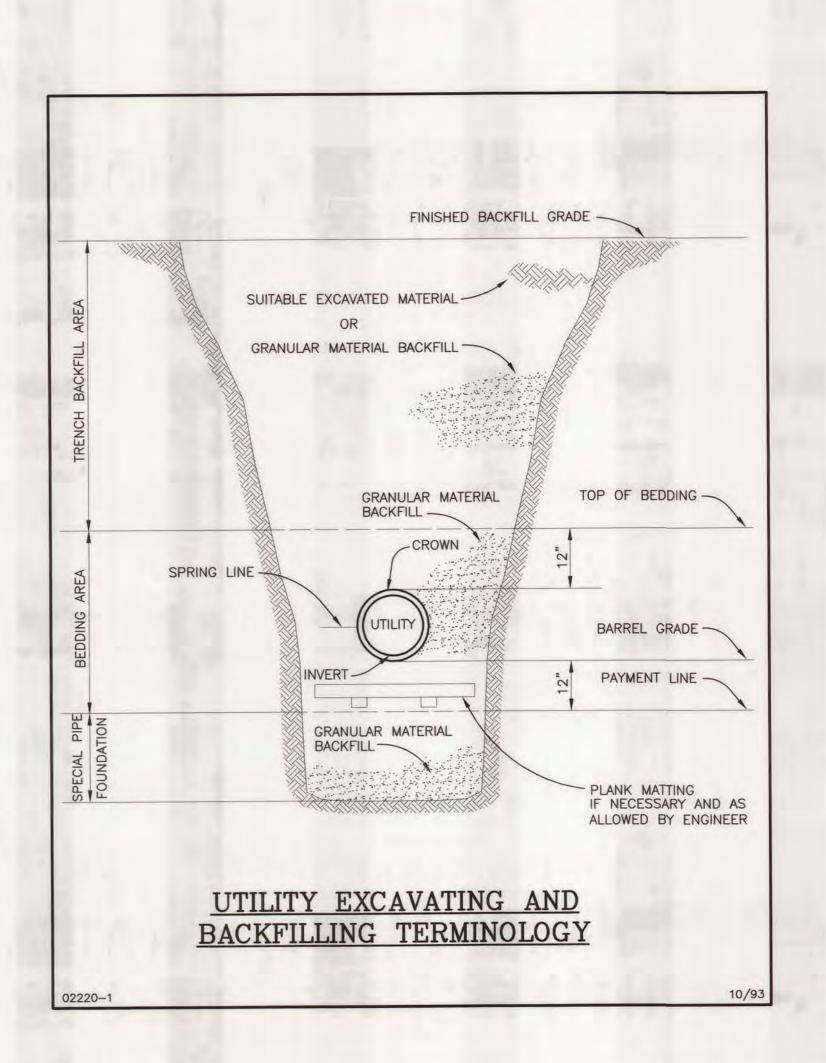



-	ISSUED FOR CONSTRUCTION	D.C.T. D.C.H.	NOV.				
0	ISSUED FOR PERMIT	D.C.T. D.C.H.	96, 100°				
NO	REVISIONS	ВУ	DATE	NO.	REVISIONS	- BY	
	REVISED IN ACCORDANCE WITH CONSTRUCTION RECORDS	WITH CONST	RUCTION	RECORDS	BY	DATE	

CITY OF ALPENA
ALPENA COUNTY, MICHIGAN
1998 WTP IMPROVEMENTS
STANDARD DETAILS

DESIGNED BY
D.C.H.
DRAWN BY
D.C.T.
CHECKED BY
J.K.P.
DATE
JUN. '98


DATE
JUN. '98

DATE
JUN. '98

EDIT
DCT102998

NONE
DRAWING
1:1
PLOT

C2

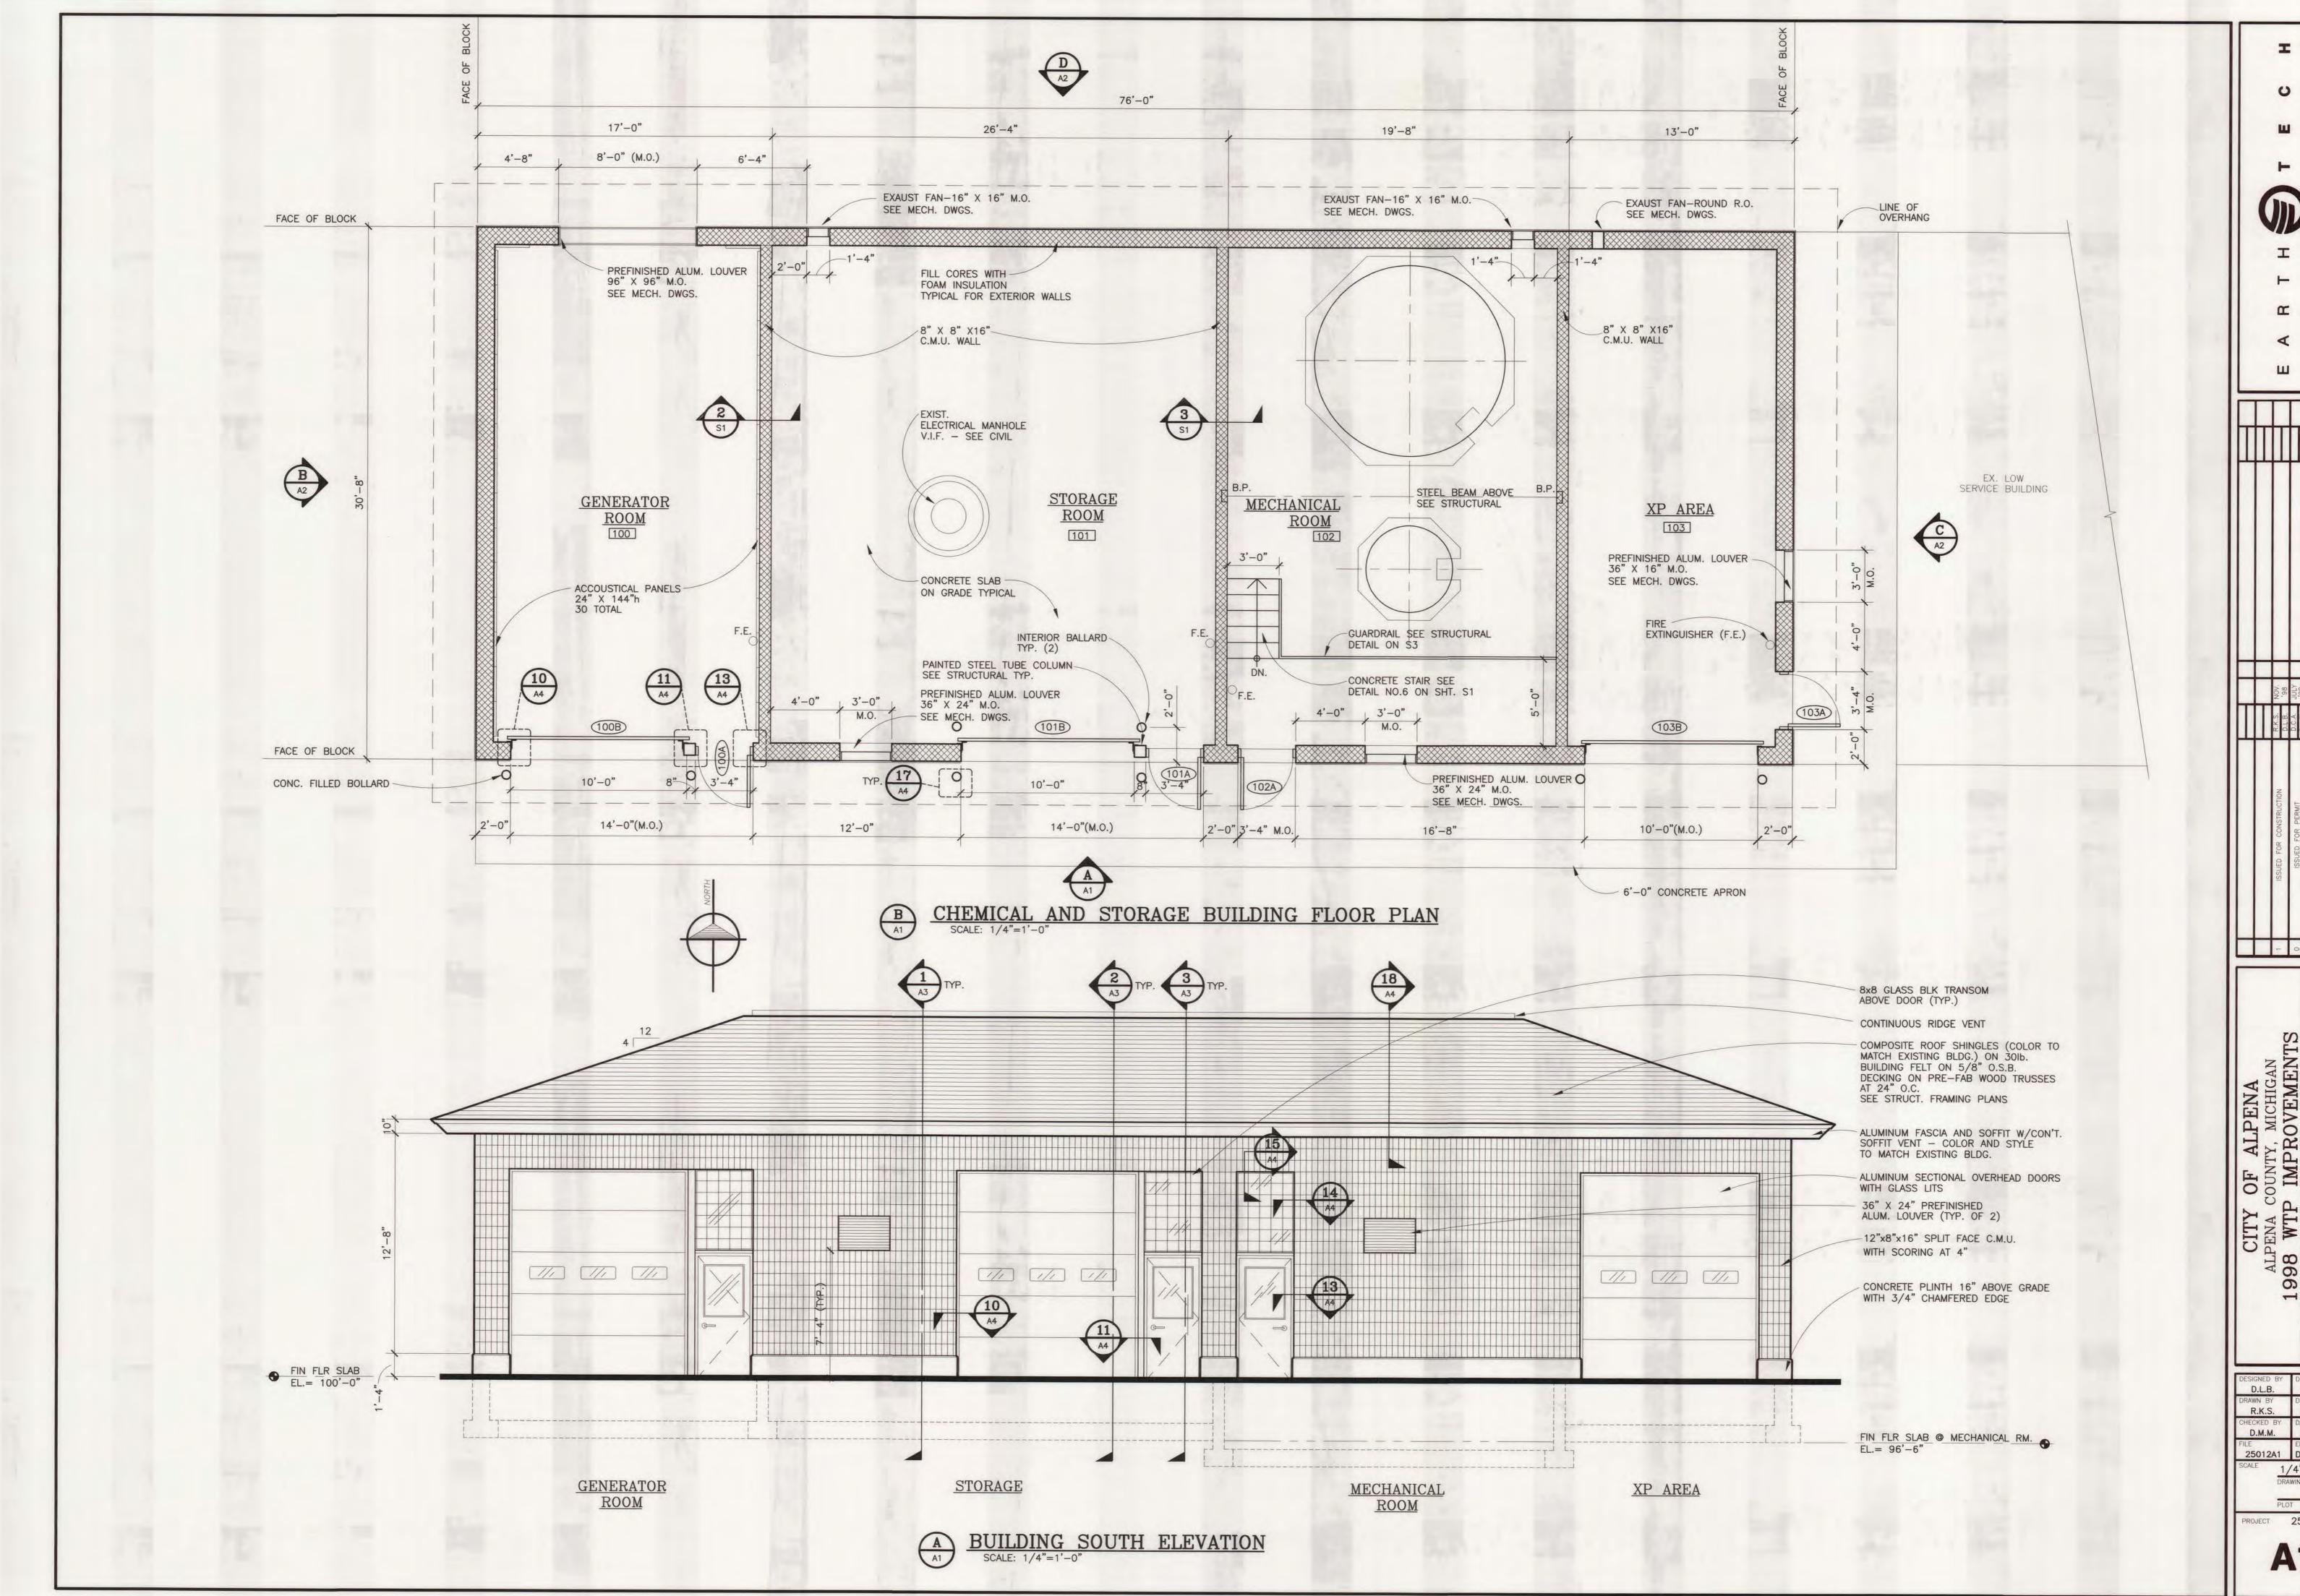

R.K.S. MAR. '98 1/4"=1'-0" DRAWING

ROJECT 25012 A1



DRAWING NUMBER

Wastewater Treatment Plant Chemical & Storage Building 1998 A2 of 19


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BUILDING WEST ELEVATION

BUILDING EAST ELEVATION

BUILDING EAST ELEVATION



E A R T H

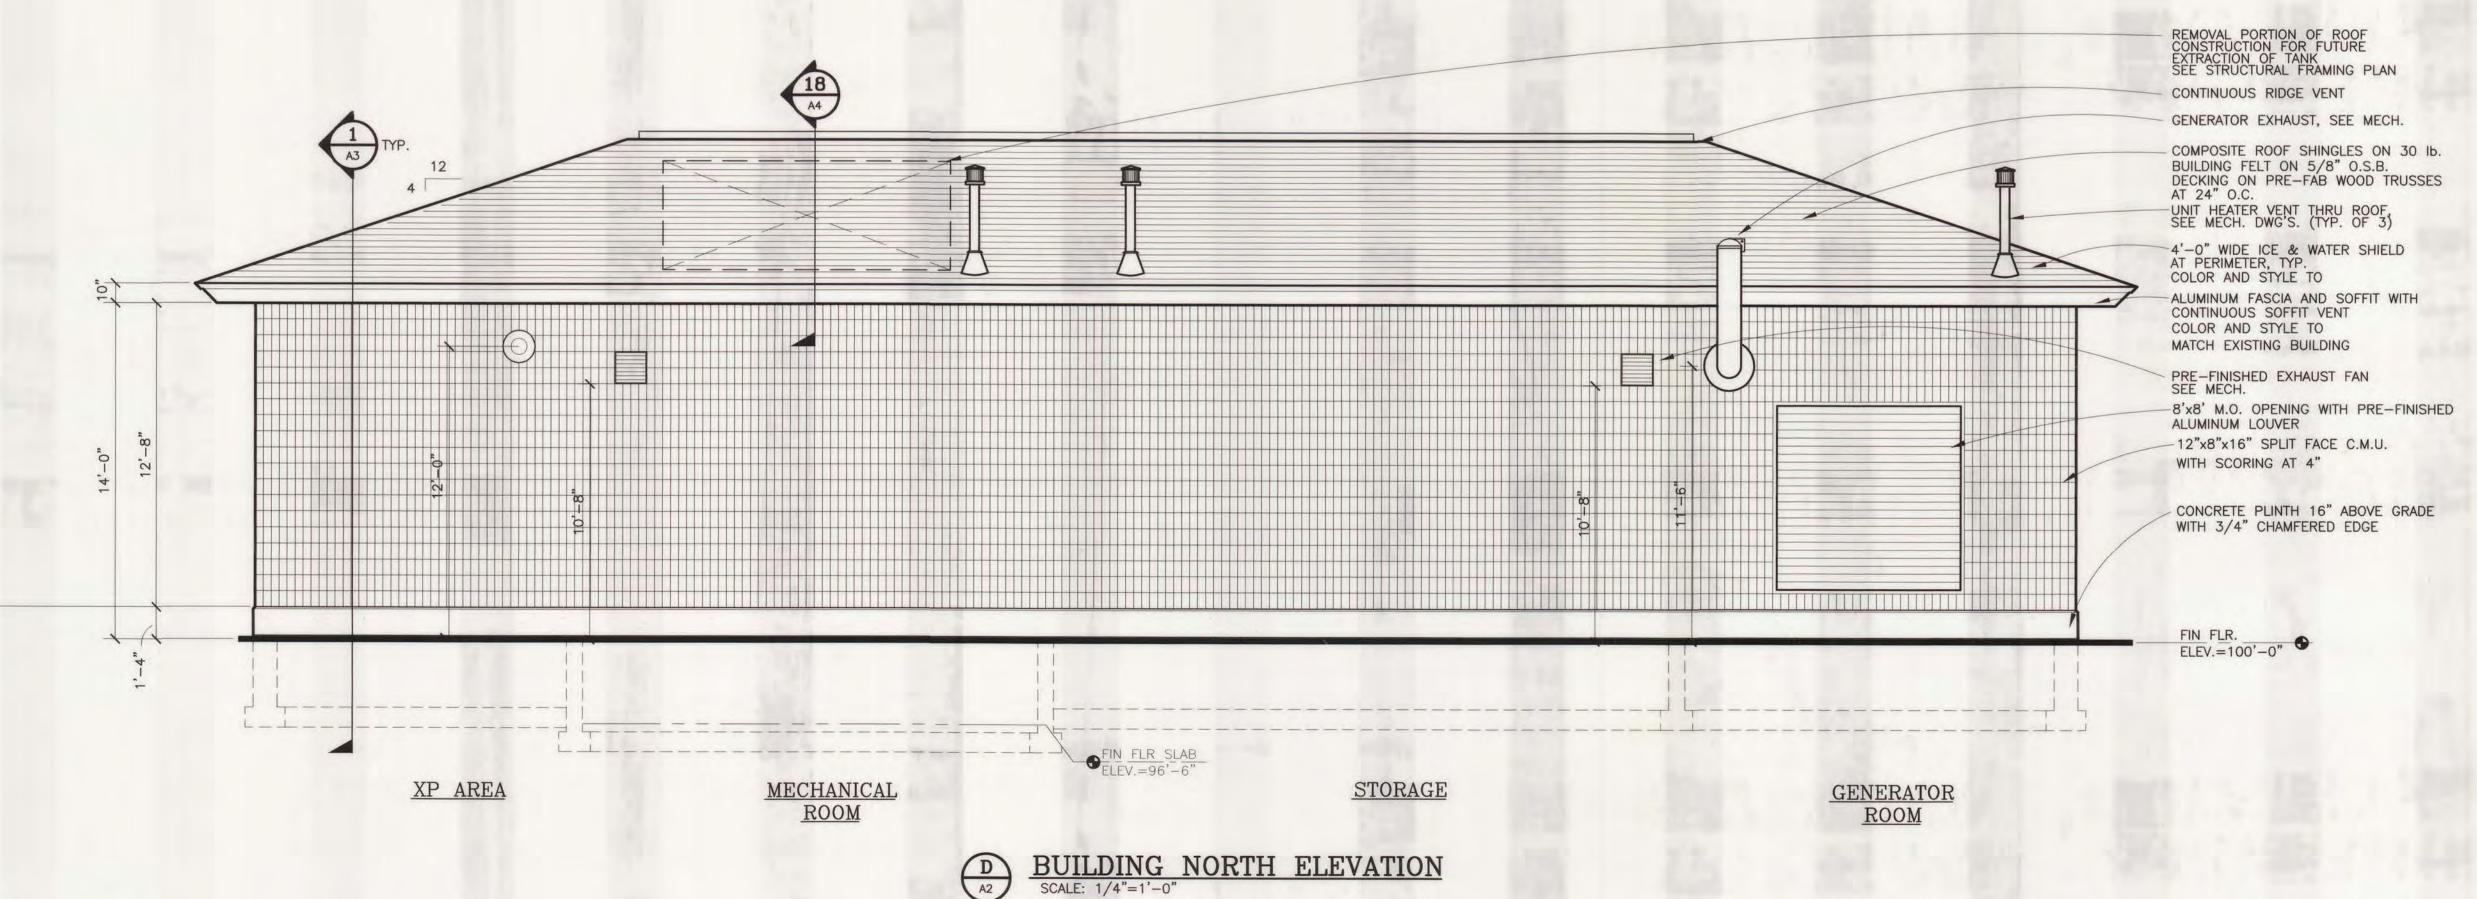
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I	I	R.K.S. N	D.C.A JI	BY D	E WITH CONSTRUC
		ISSUED FOR CONSTRUCTION	ISSUED FOR REVIEW	REVISIONS	REVISED IN ACCORDANCE WITH CONSTRUCTION PECUADO
		1	0	NO.	

ALPENA COUNTY, MICH 1998 WTP IMPROVE CHEMICAL AND STORA

DESIGNED BY	DATE
D.L.B.	MAR. '98
DRAWN BY	DATE
R.K.S.	MAR. '98
CHECKED BY	DATE
D.M.M.	MAR. '98
FILE	EDIT
25012A2	DCT102998
	/4"=1'-0" WING 1:1

PLOT
PROJECT 25012

A2

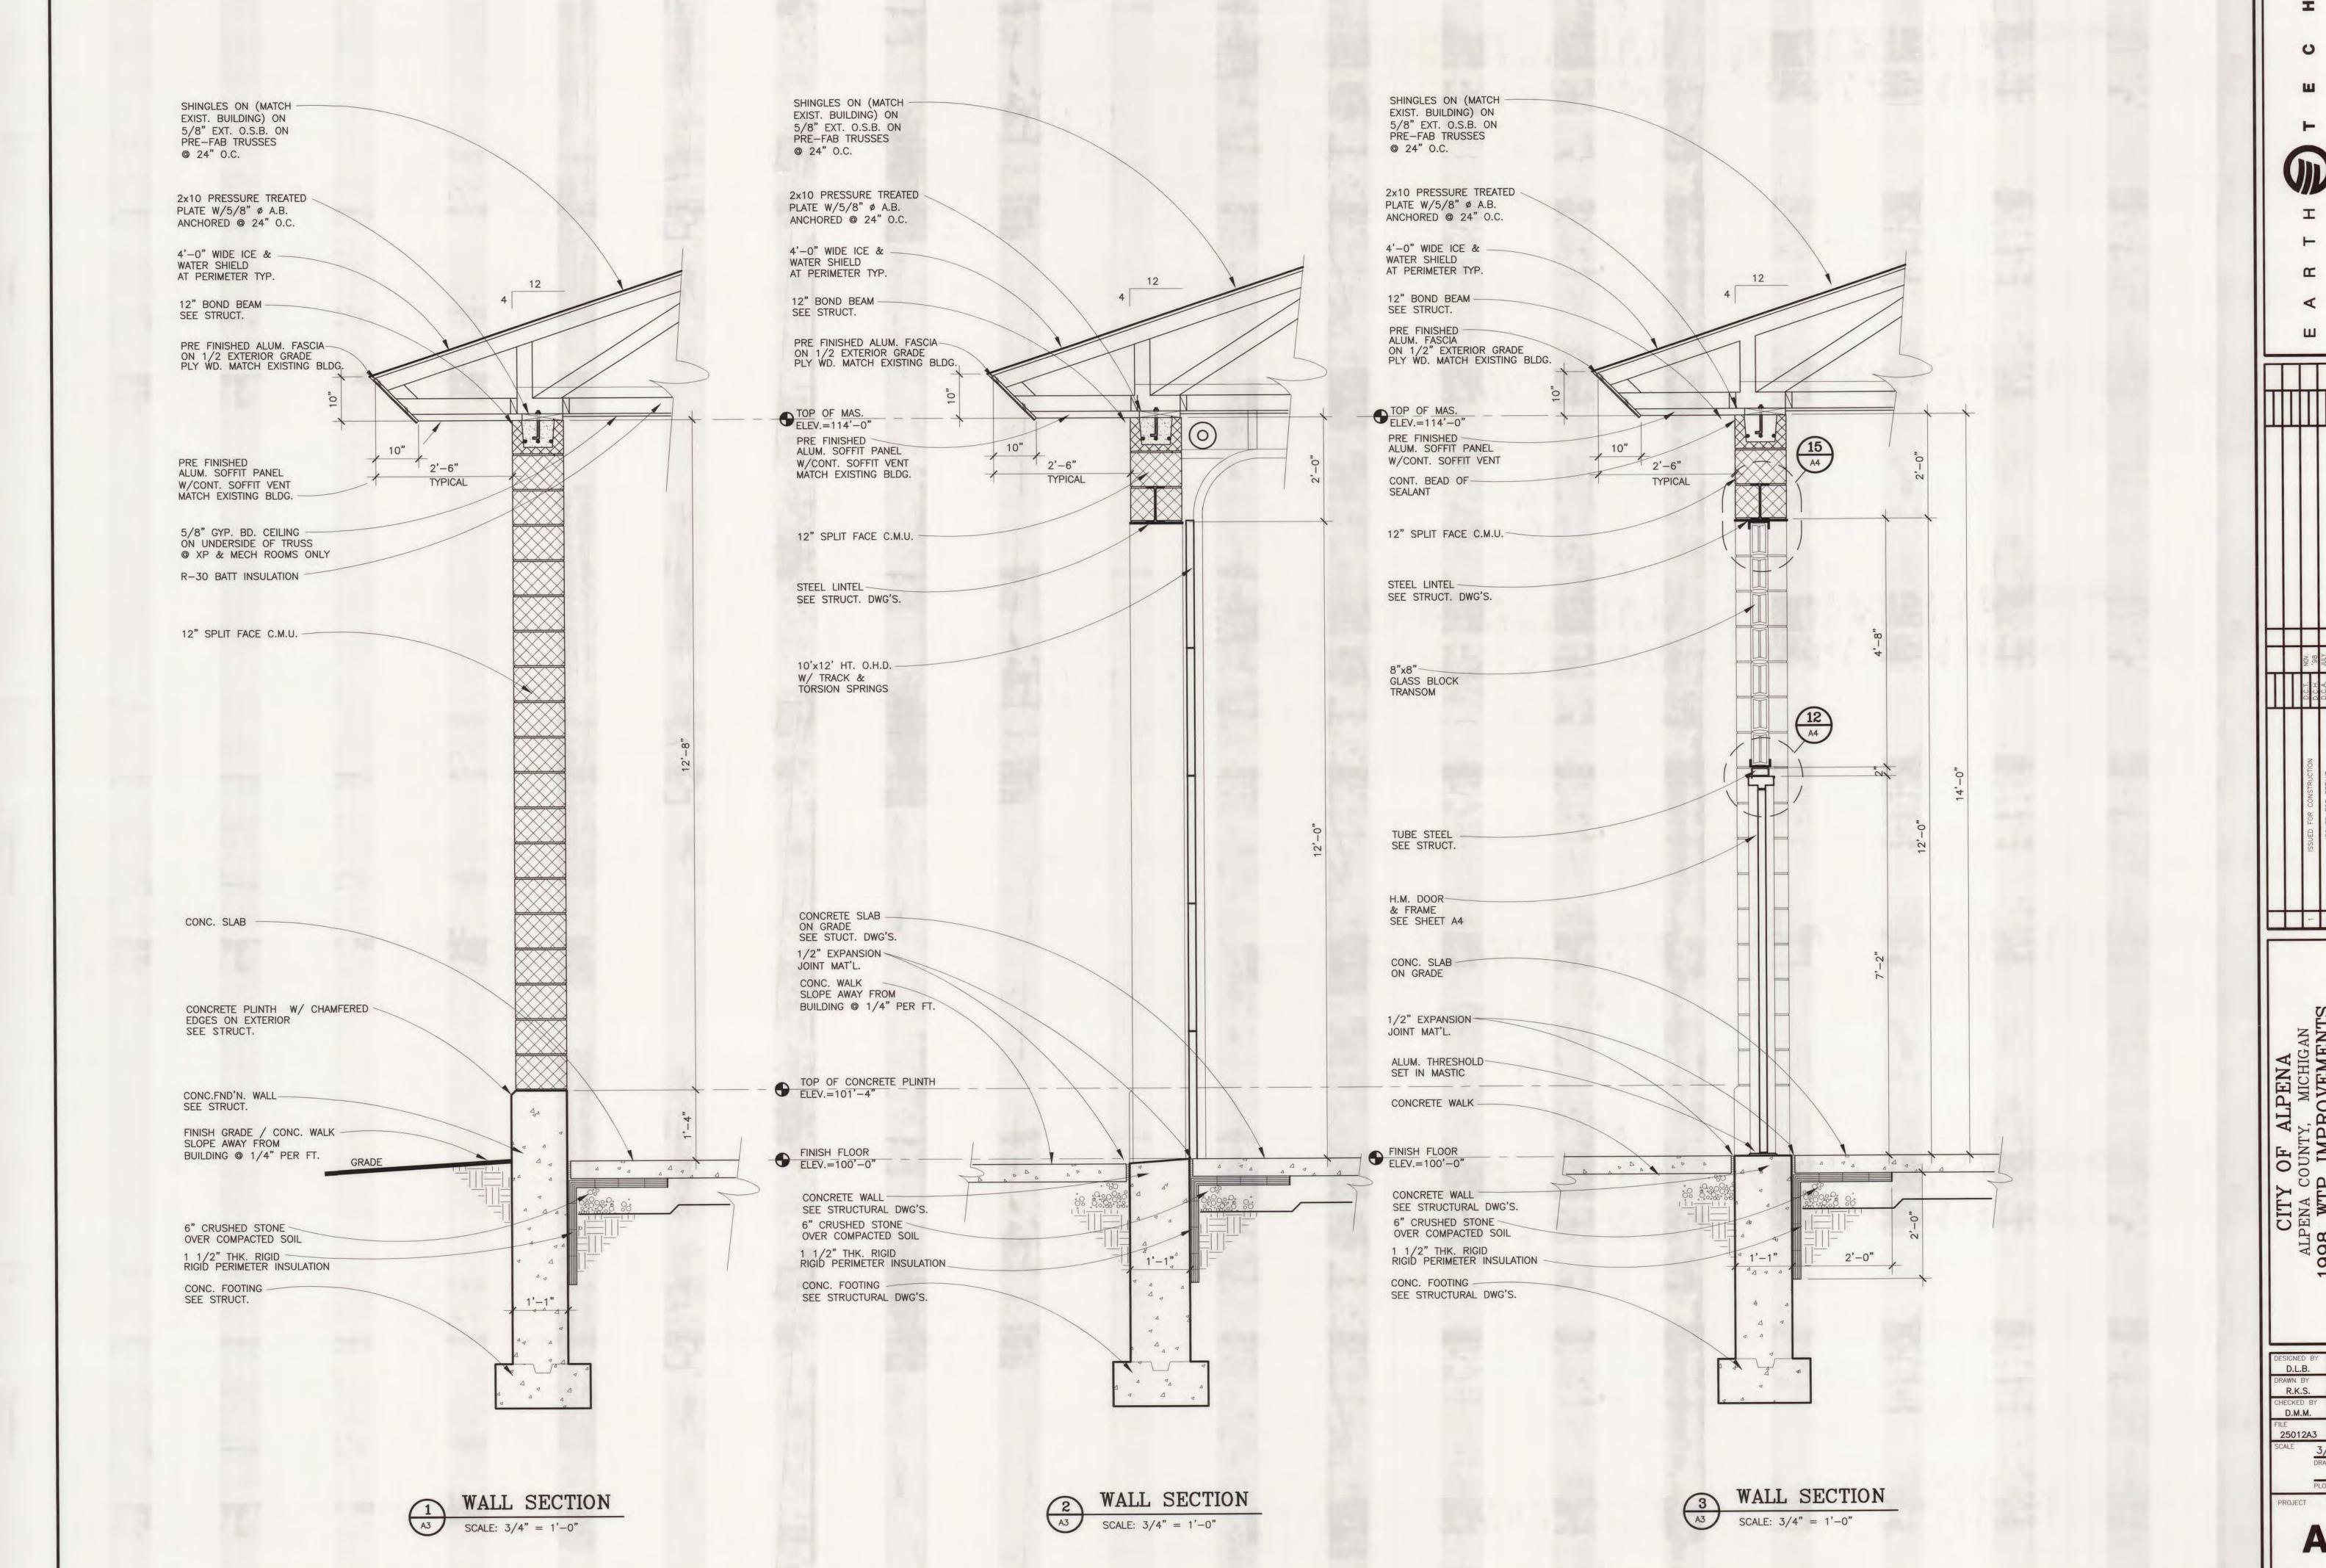

25012A3 DCT102998 3/4"=1'-0"

ROJECT 25012


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D.L.B. E.C.B. D.L.B. AS NOTED

1:1 PLOT


OJECT 25012


A4

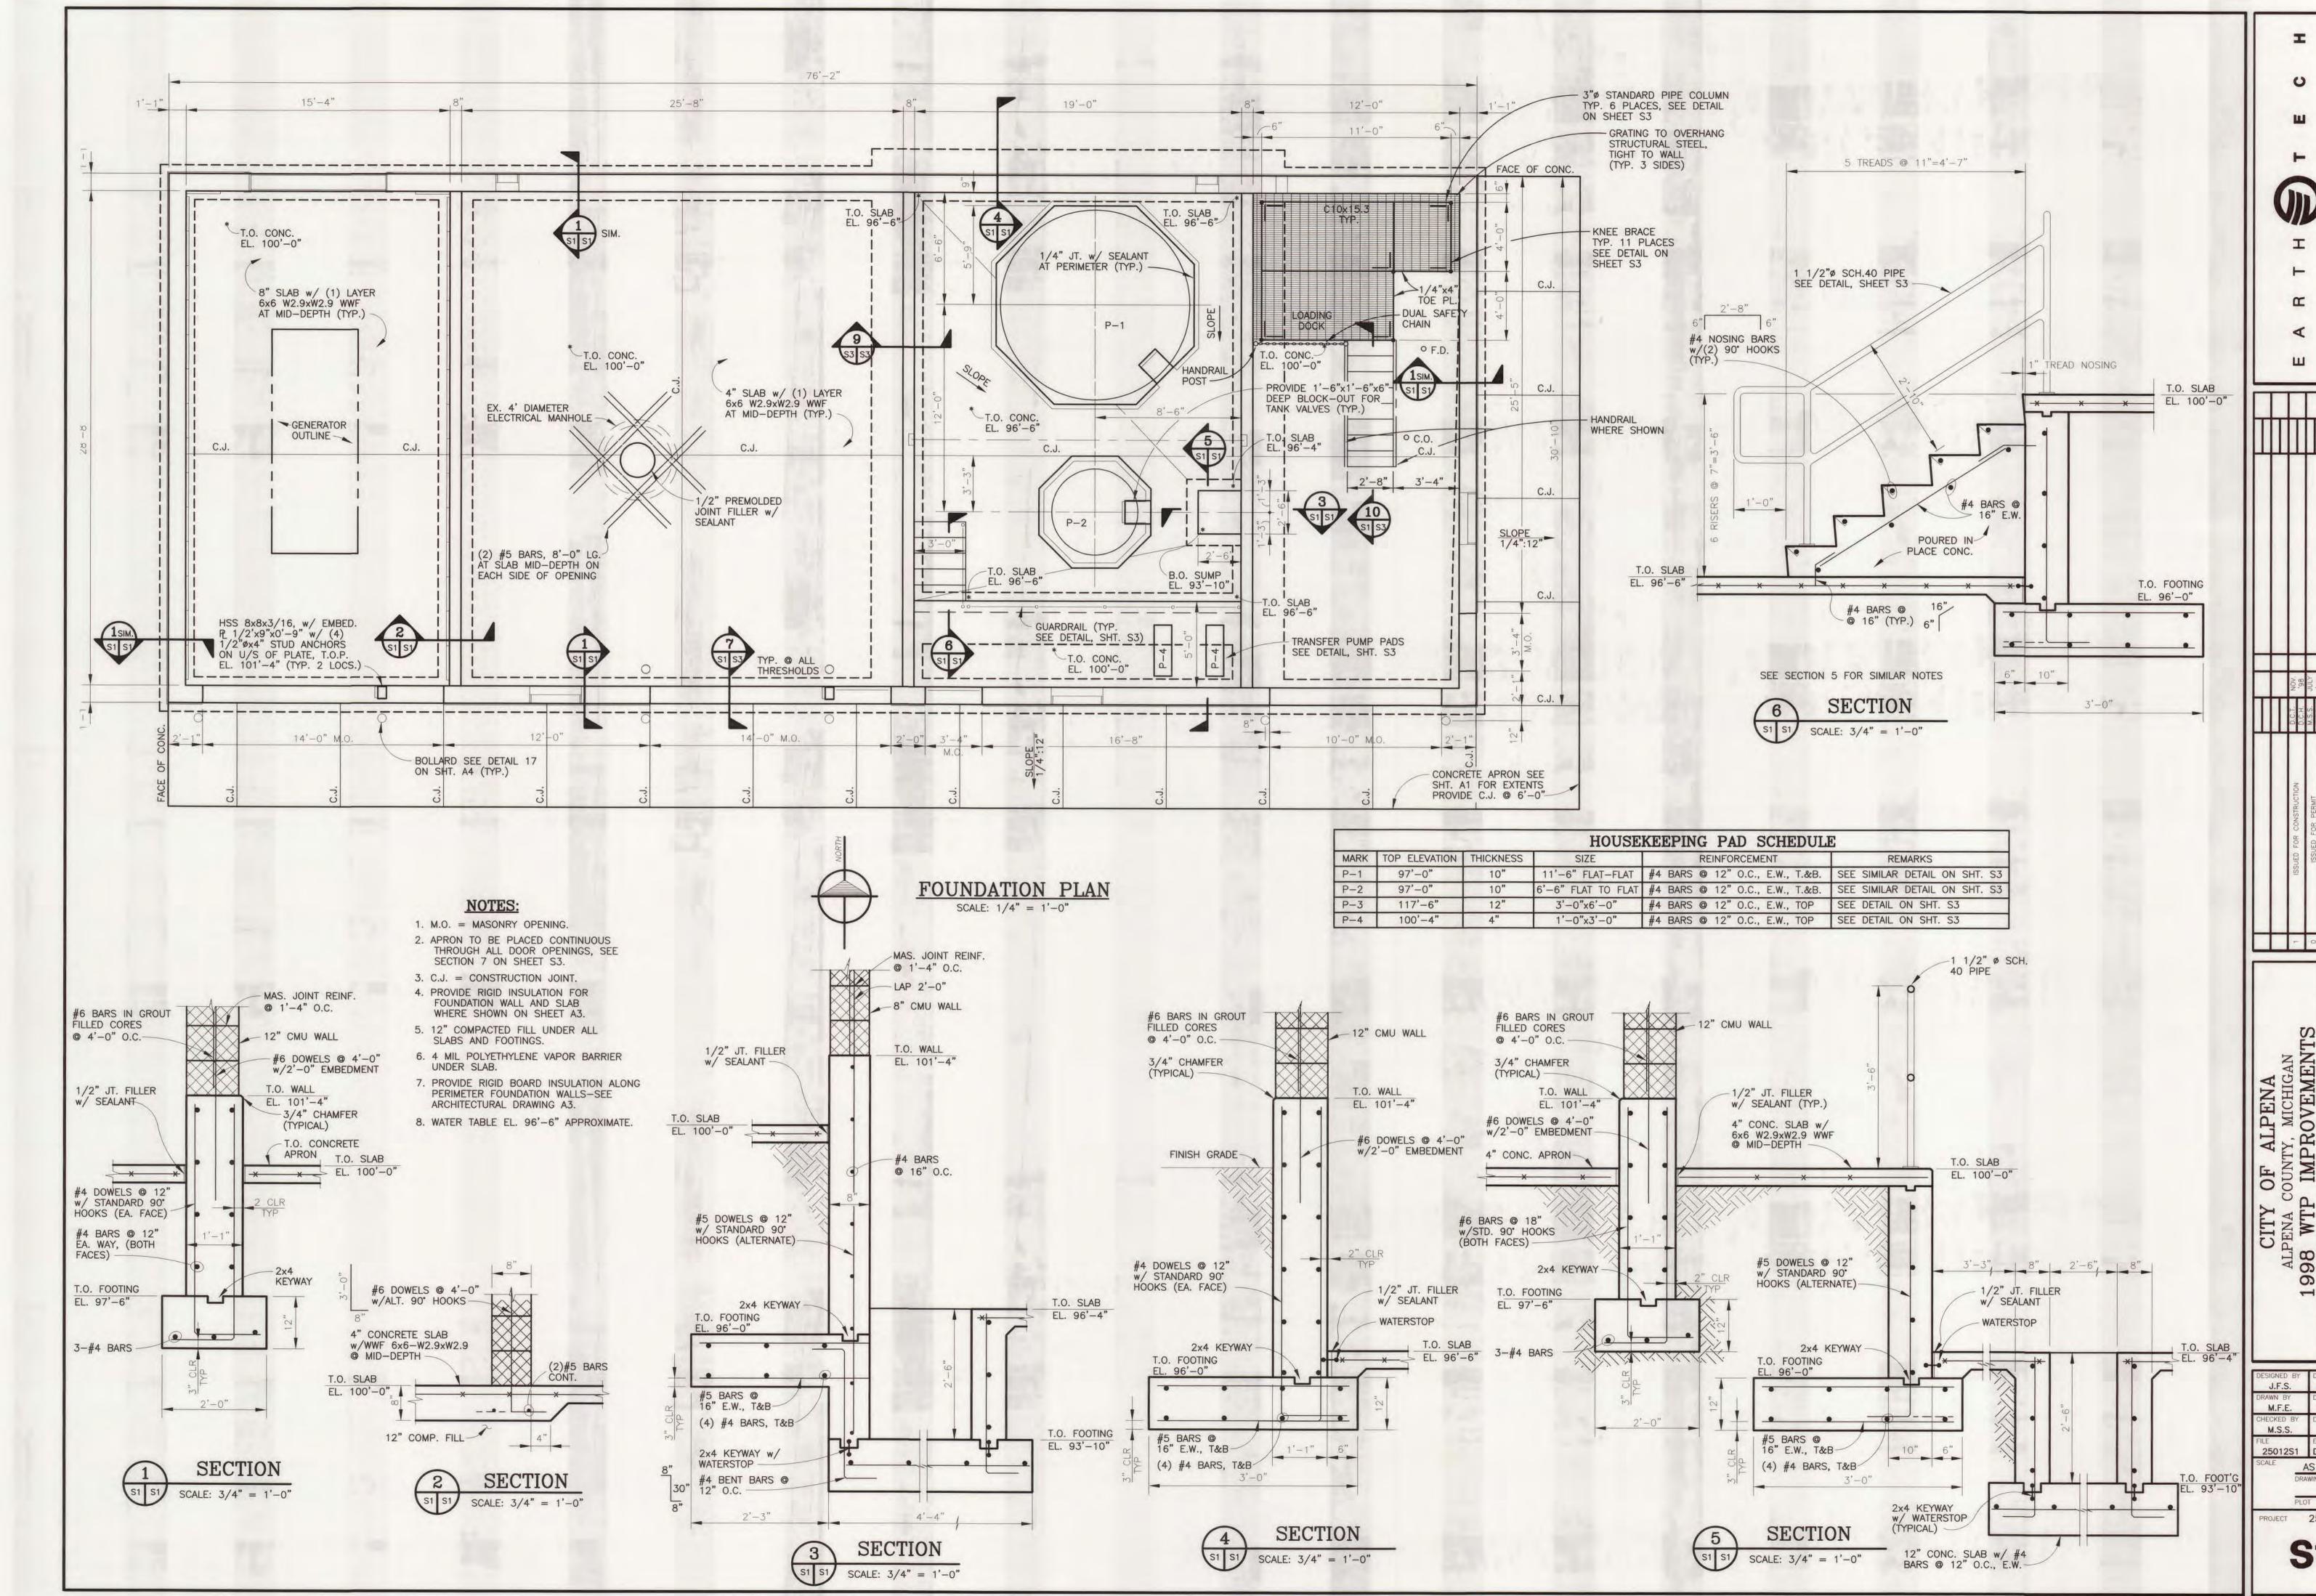


J.F.S. MAR. '98

MAR. '98 AS NOTED 1:1 25012

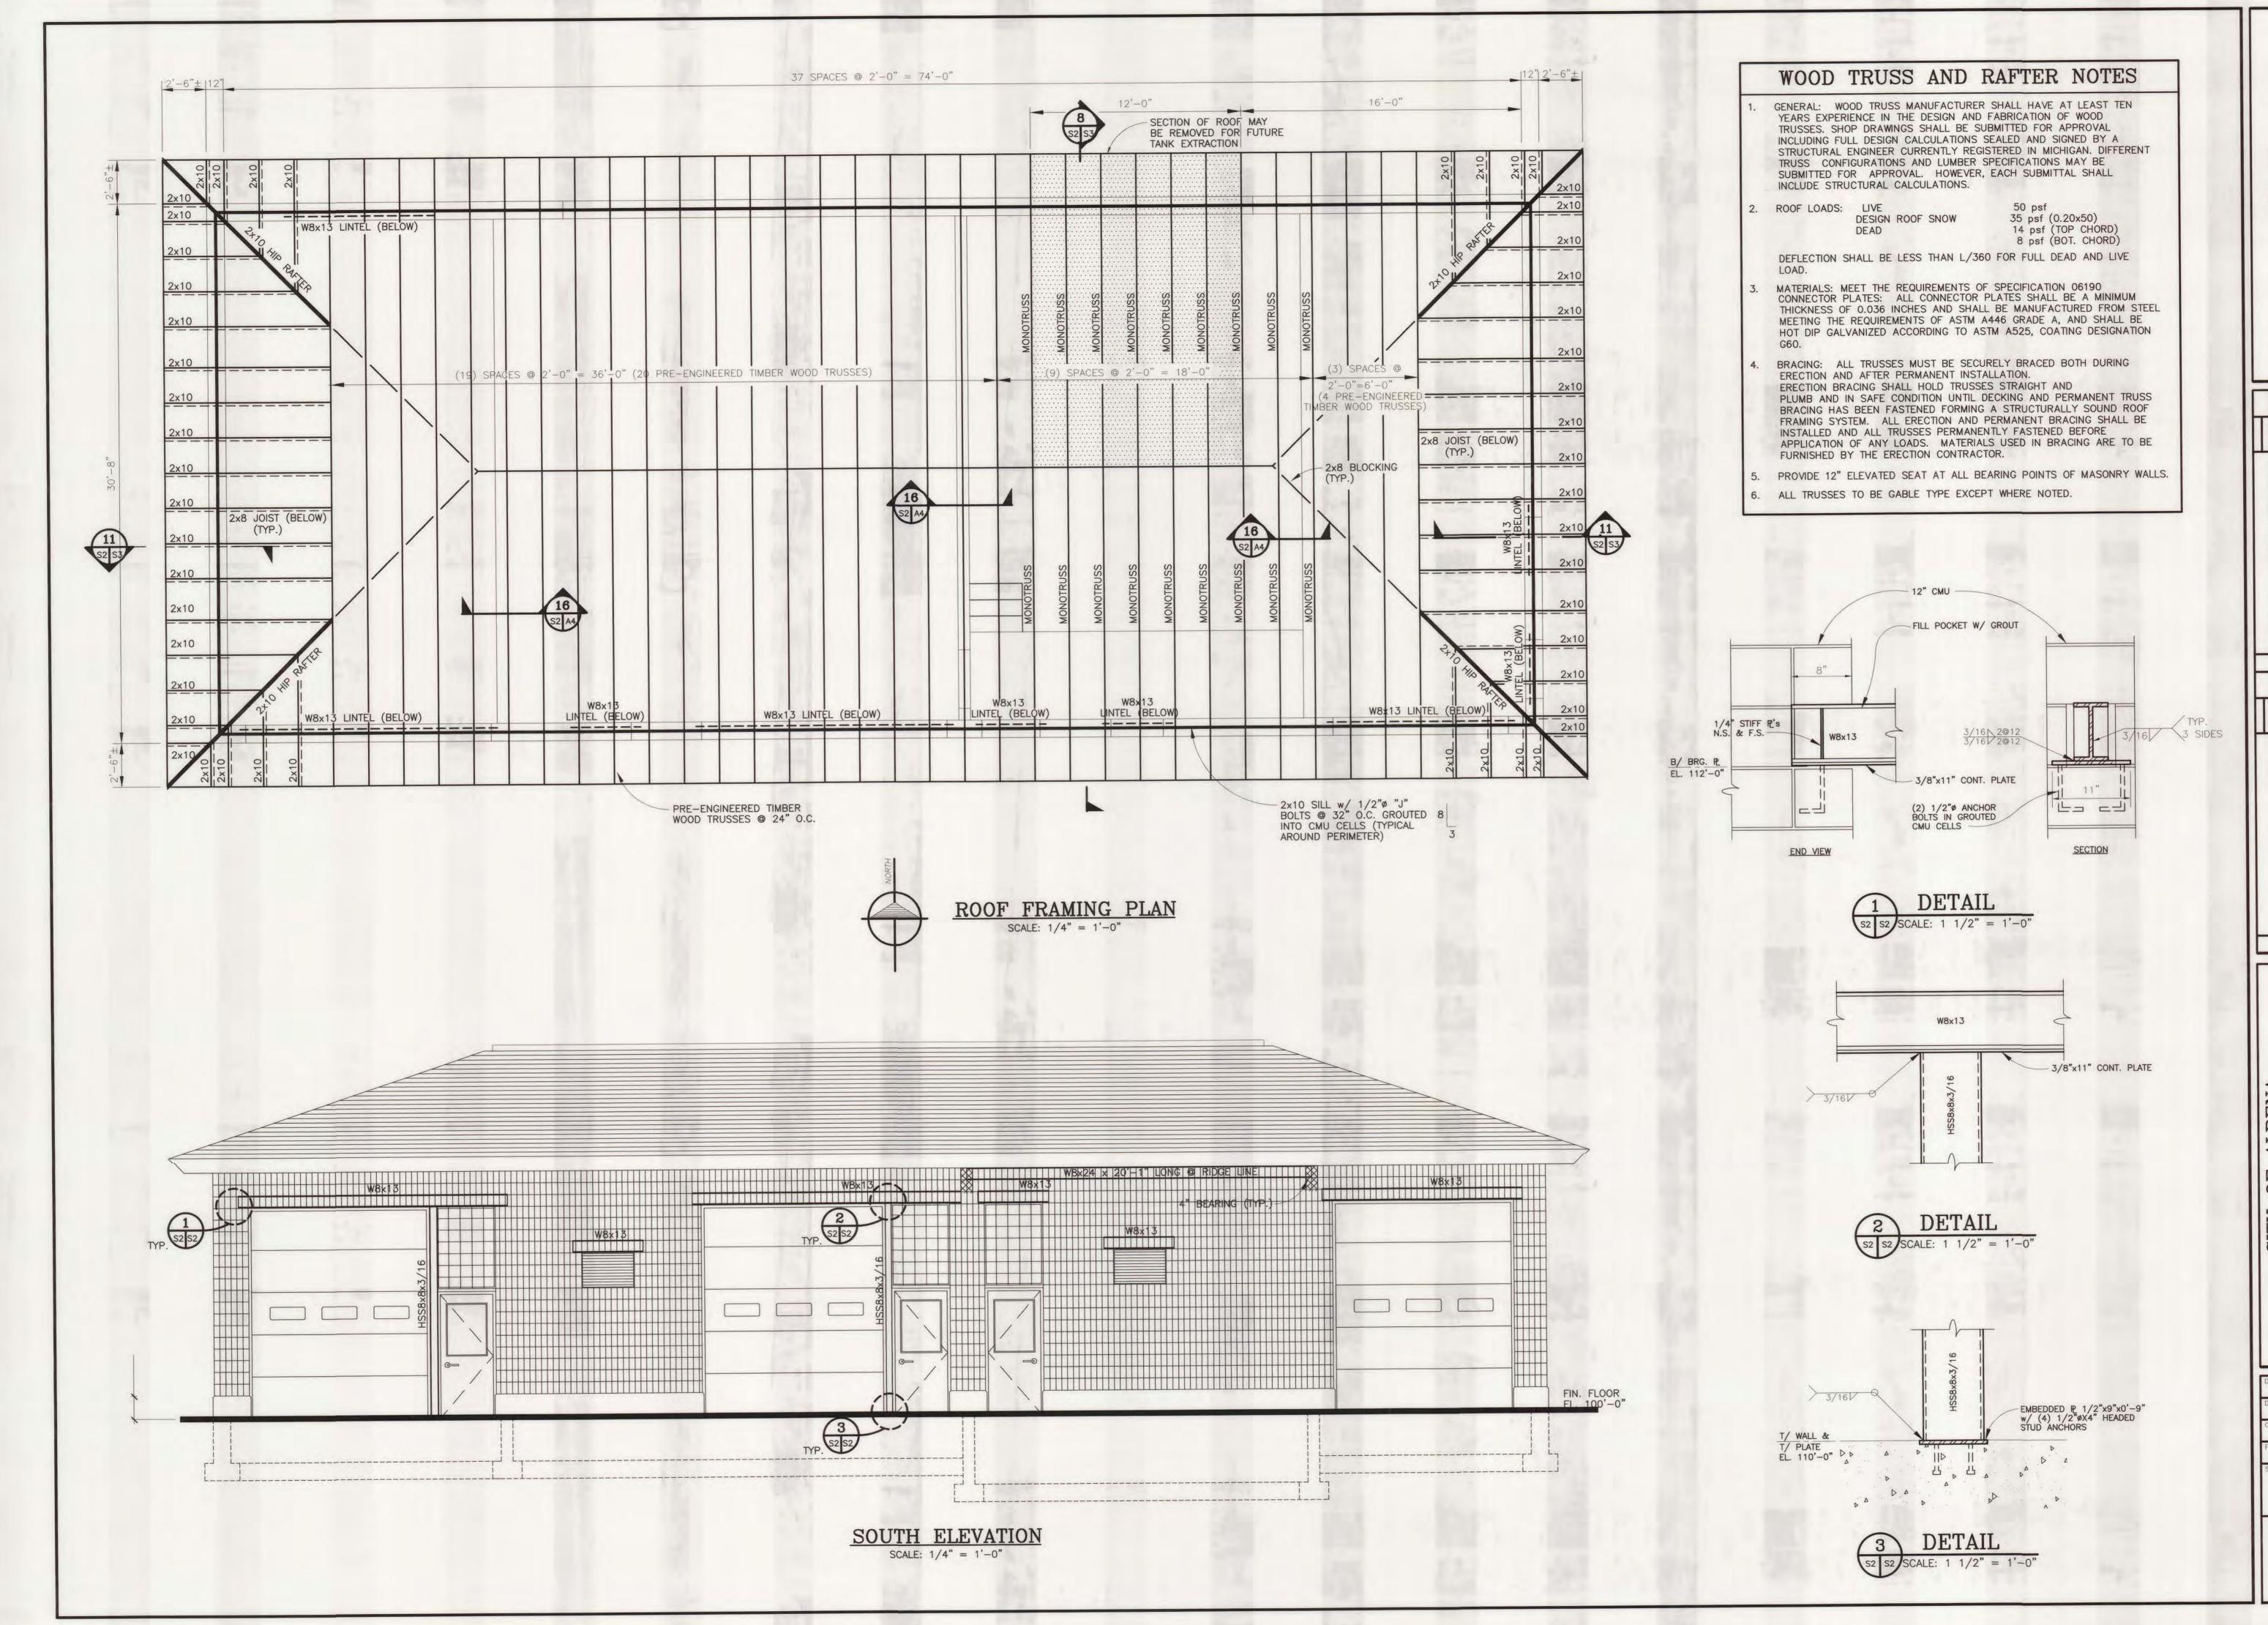

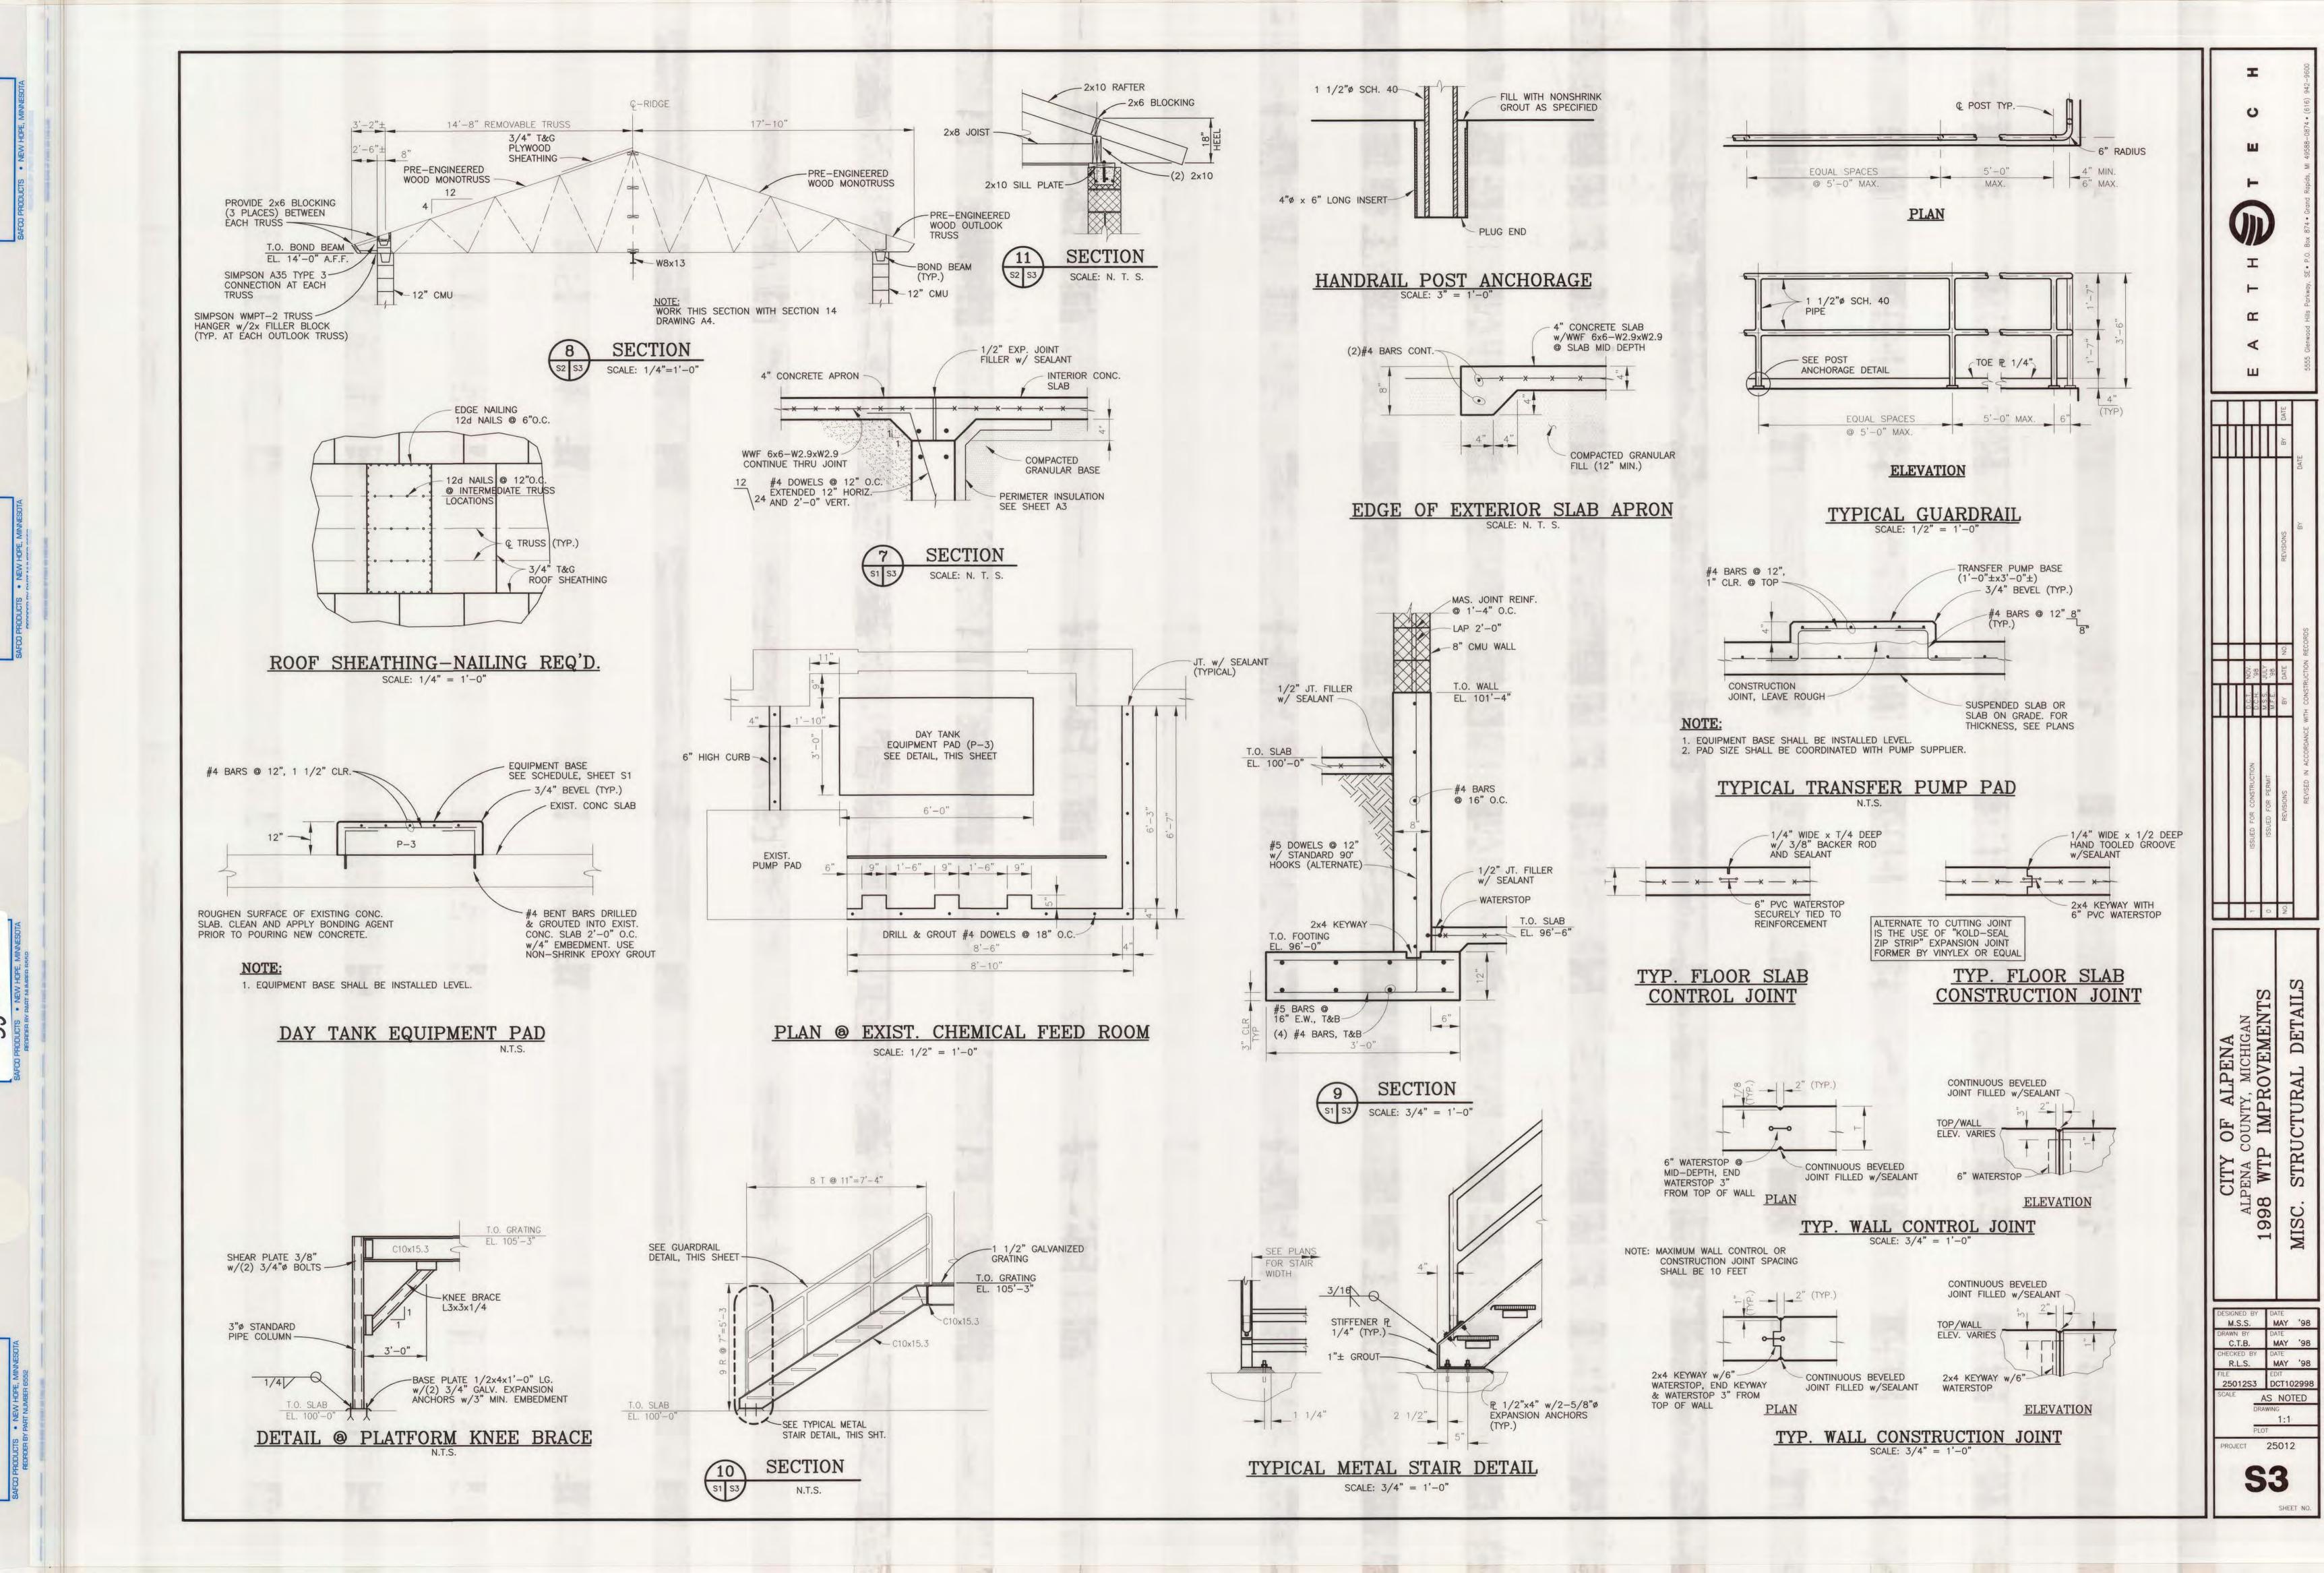

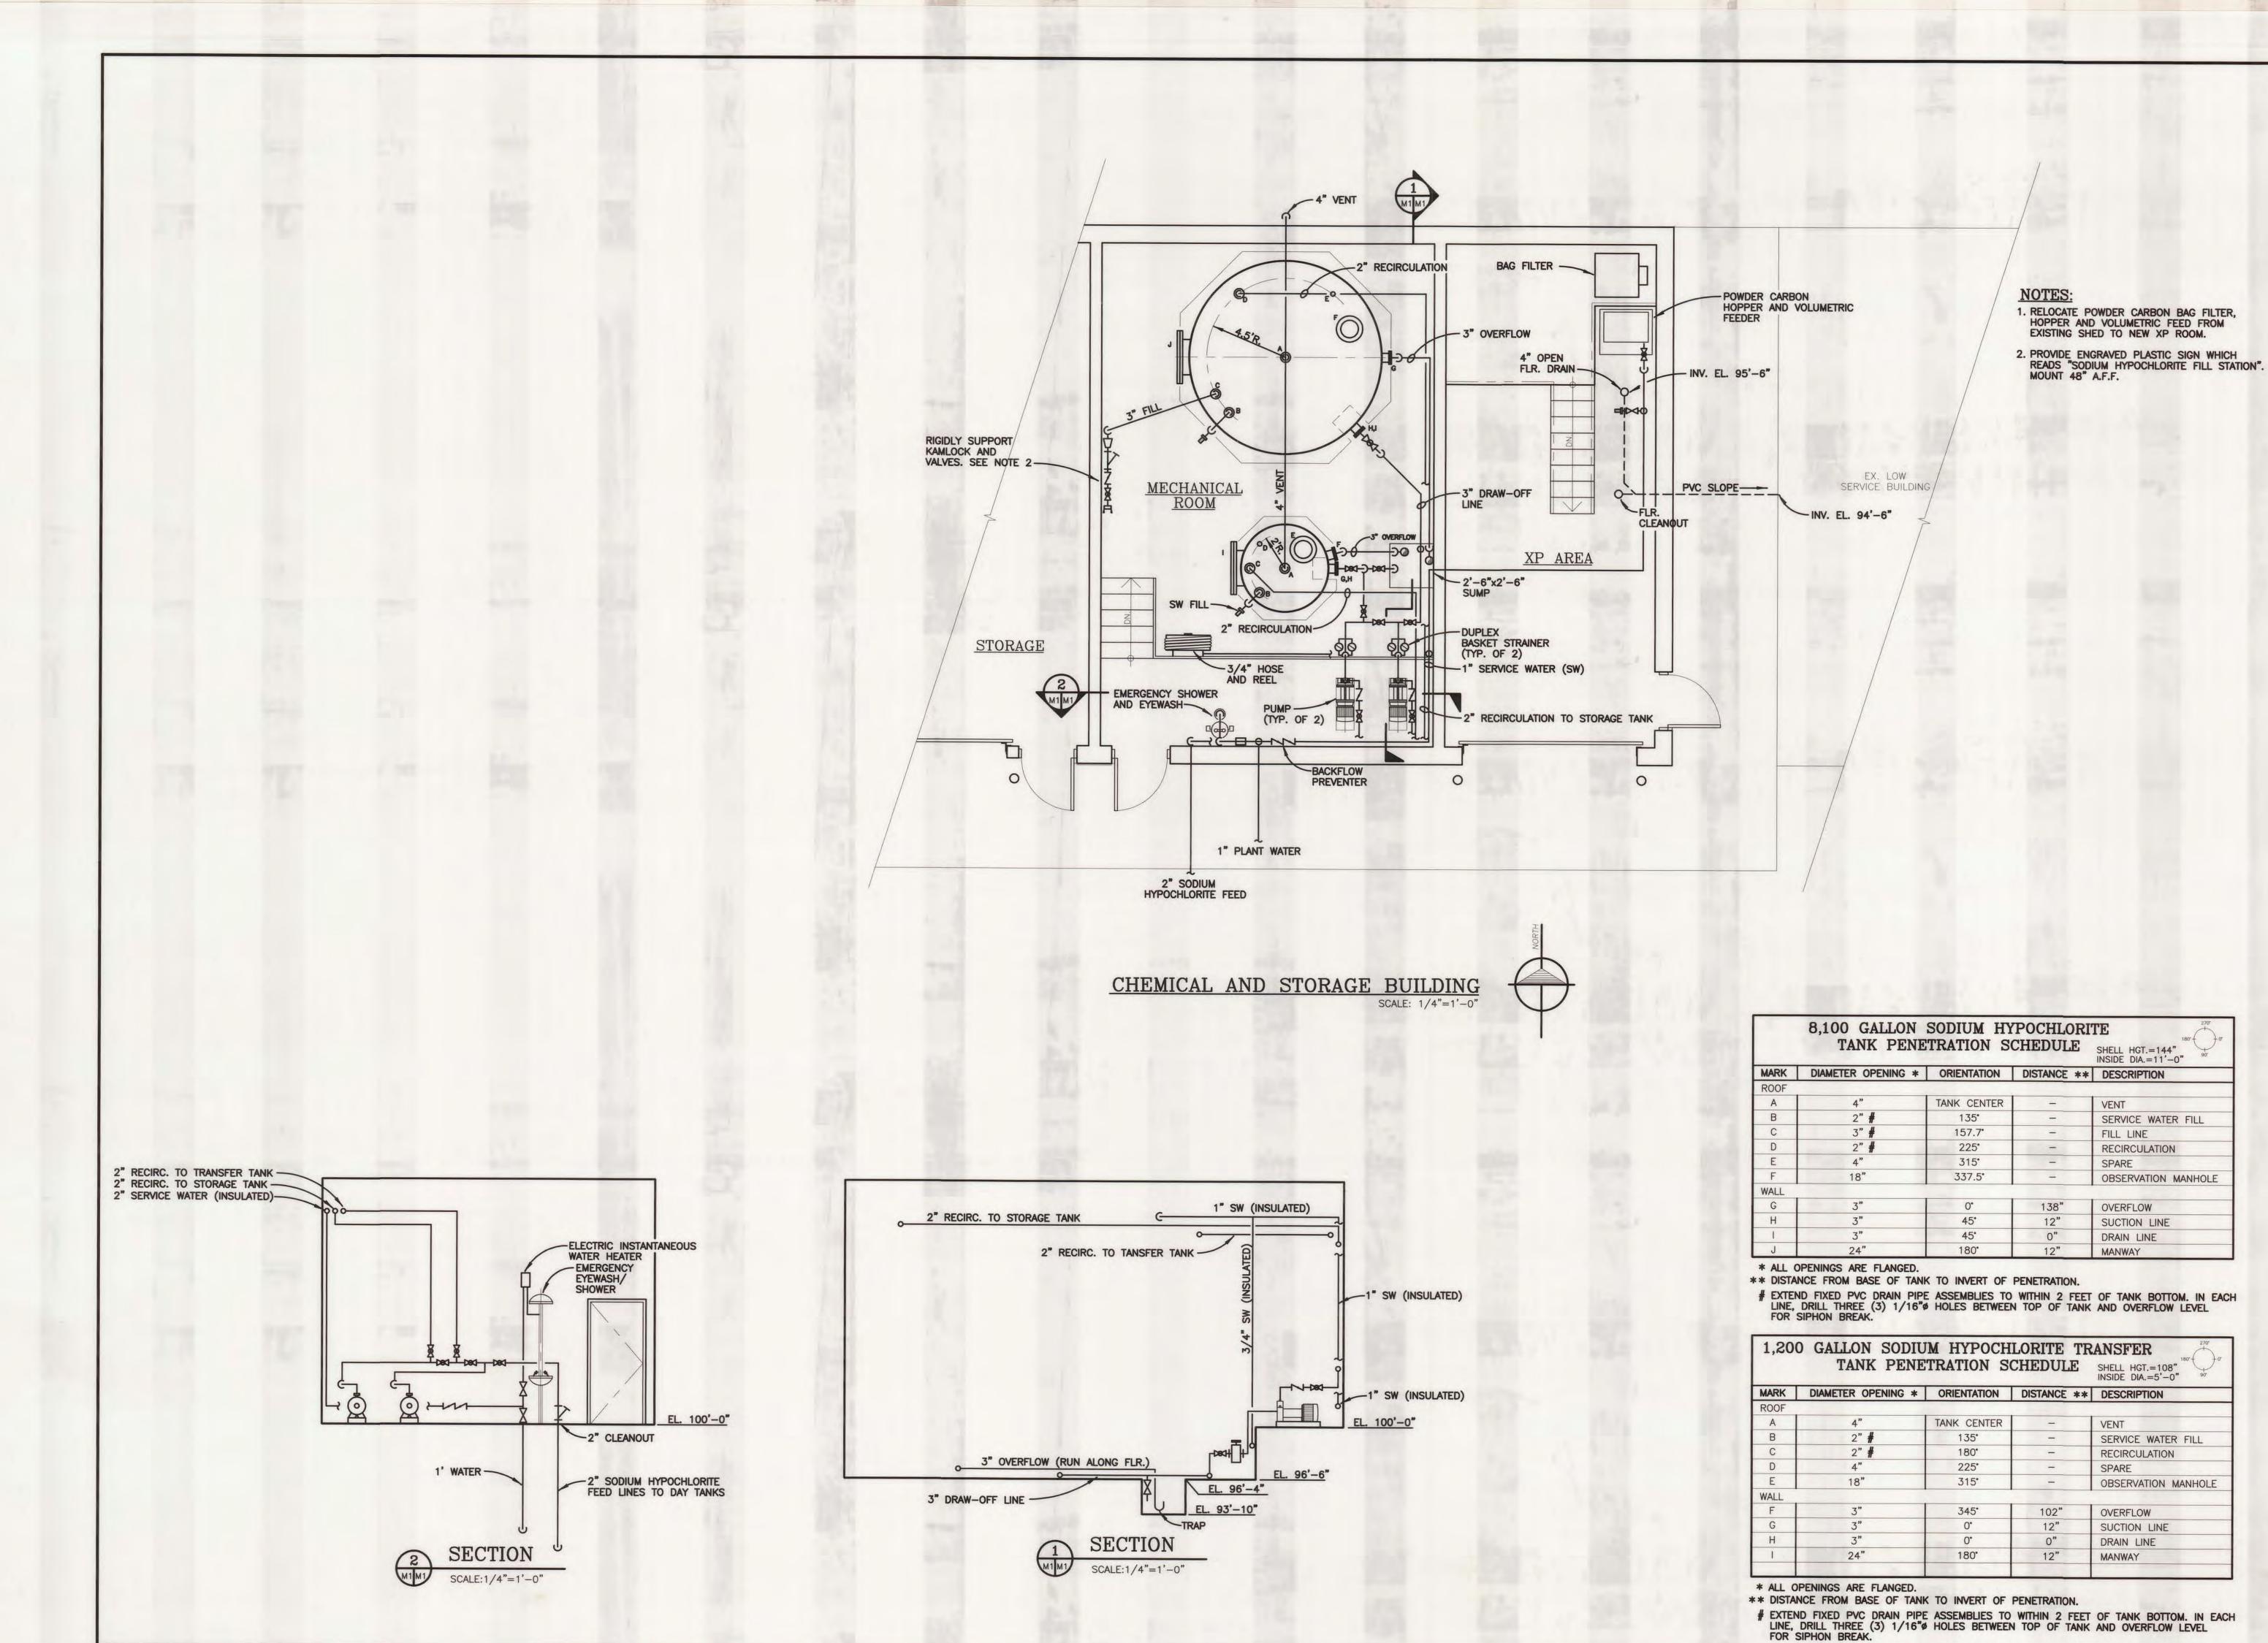

BY DATE FEER Claused Hills Davisory CF. DO Day 874 Cand Davids M. Accos 2077 Cand


CITY OF ALPENA
ALPENA COUNTY, MICHIGAN
1998 WTP IMPROVEMENTS
CHEMICAL AND STORAGE BUILDING PLAN
CHEMICAL FEED PIPING LAYOUT

NED BY DATE
C.H. JUN. '98
N BY DATE
C.T. JUN. '98
KED BY DATE
JUN. '98
EDIT
DCT102998


1/4"=1'-0"

1:48 PLOT JECT 25012

M1

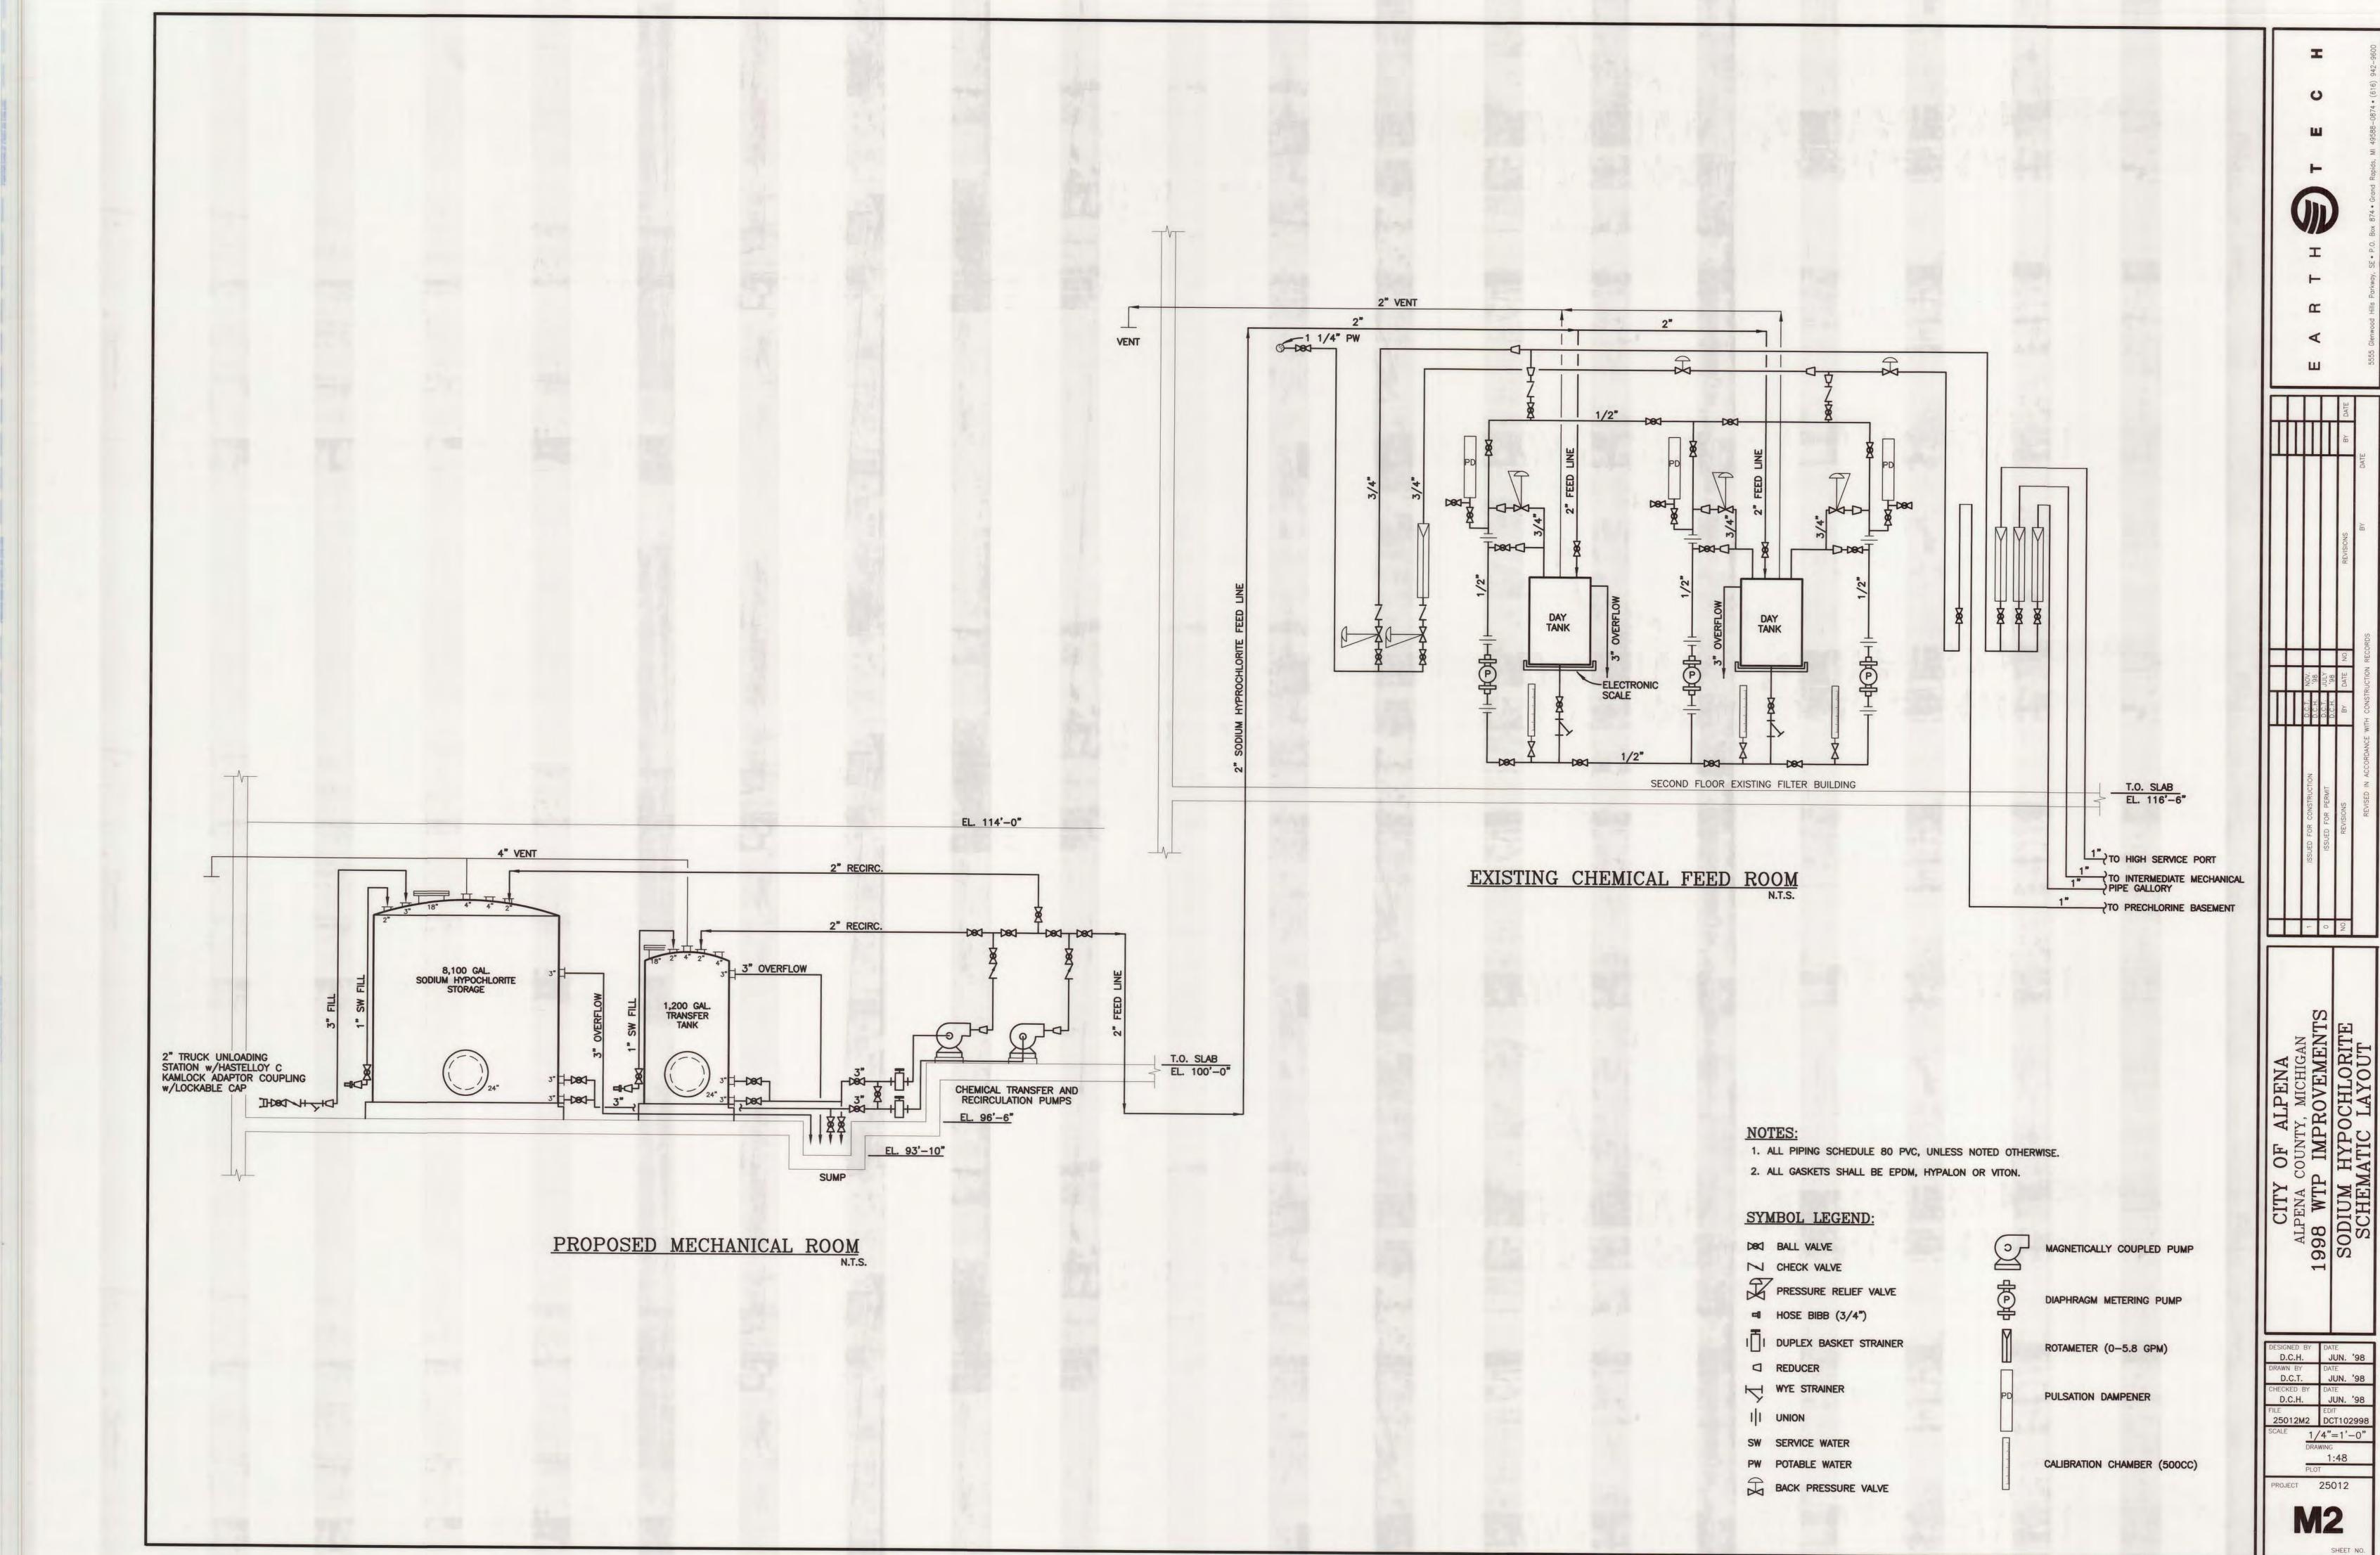


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FEED ROOM PLANS OF.

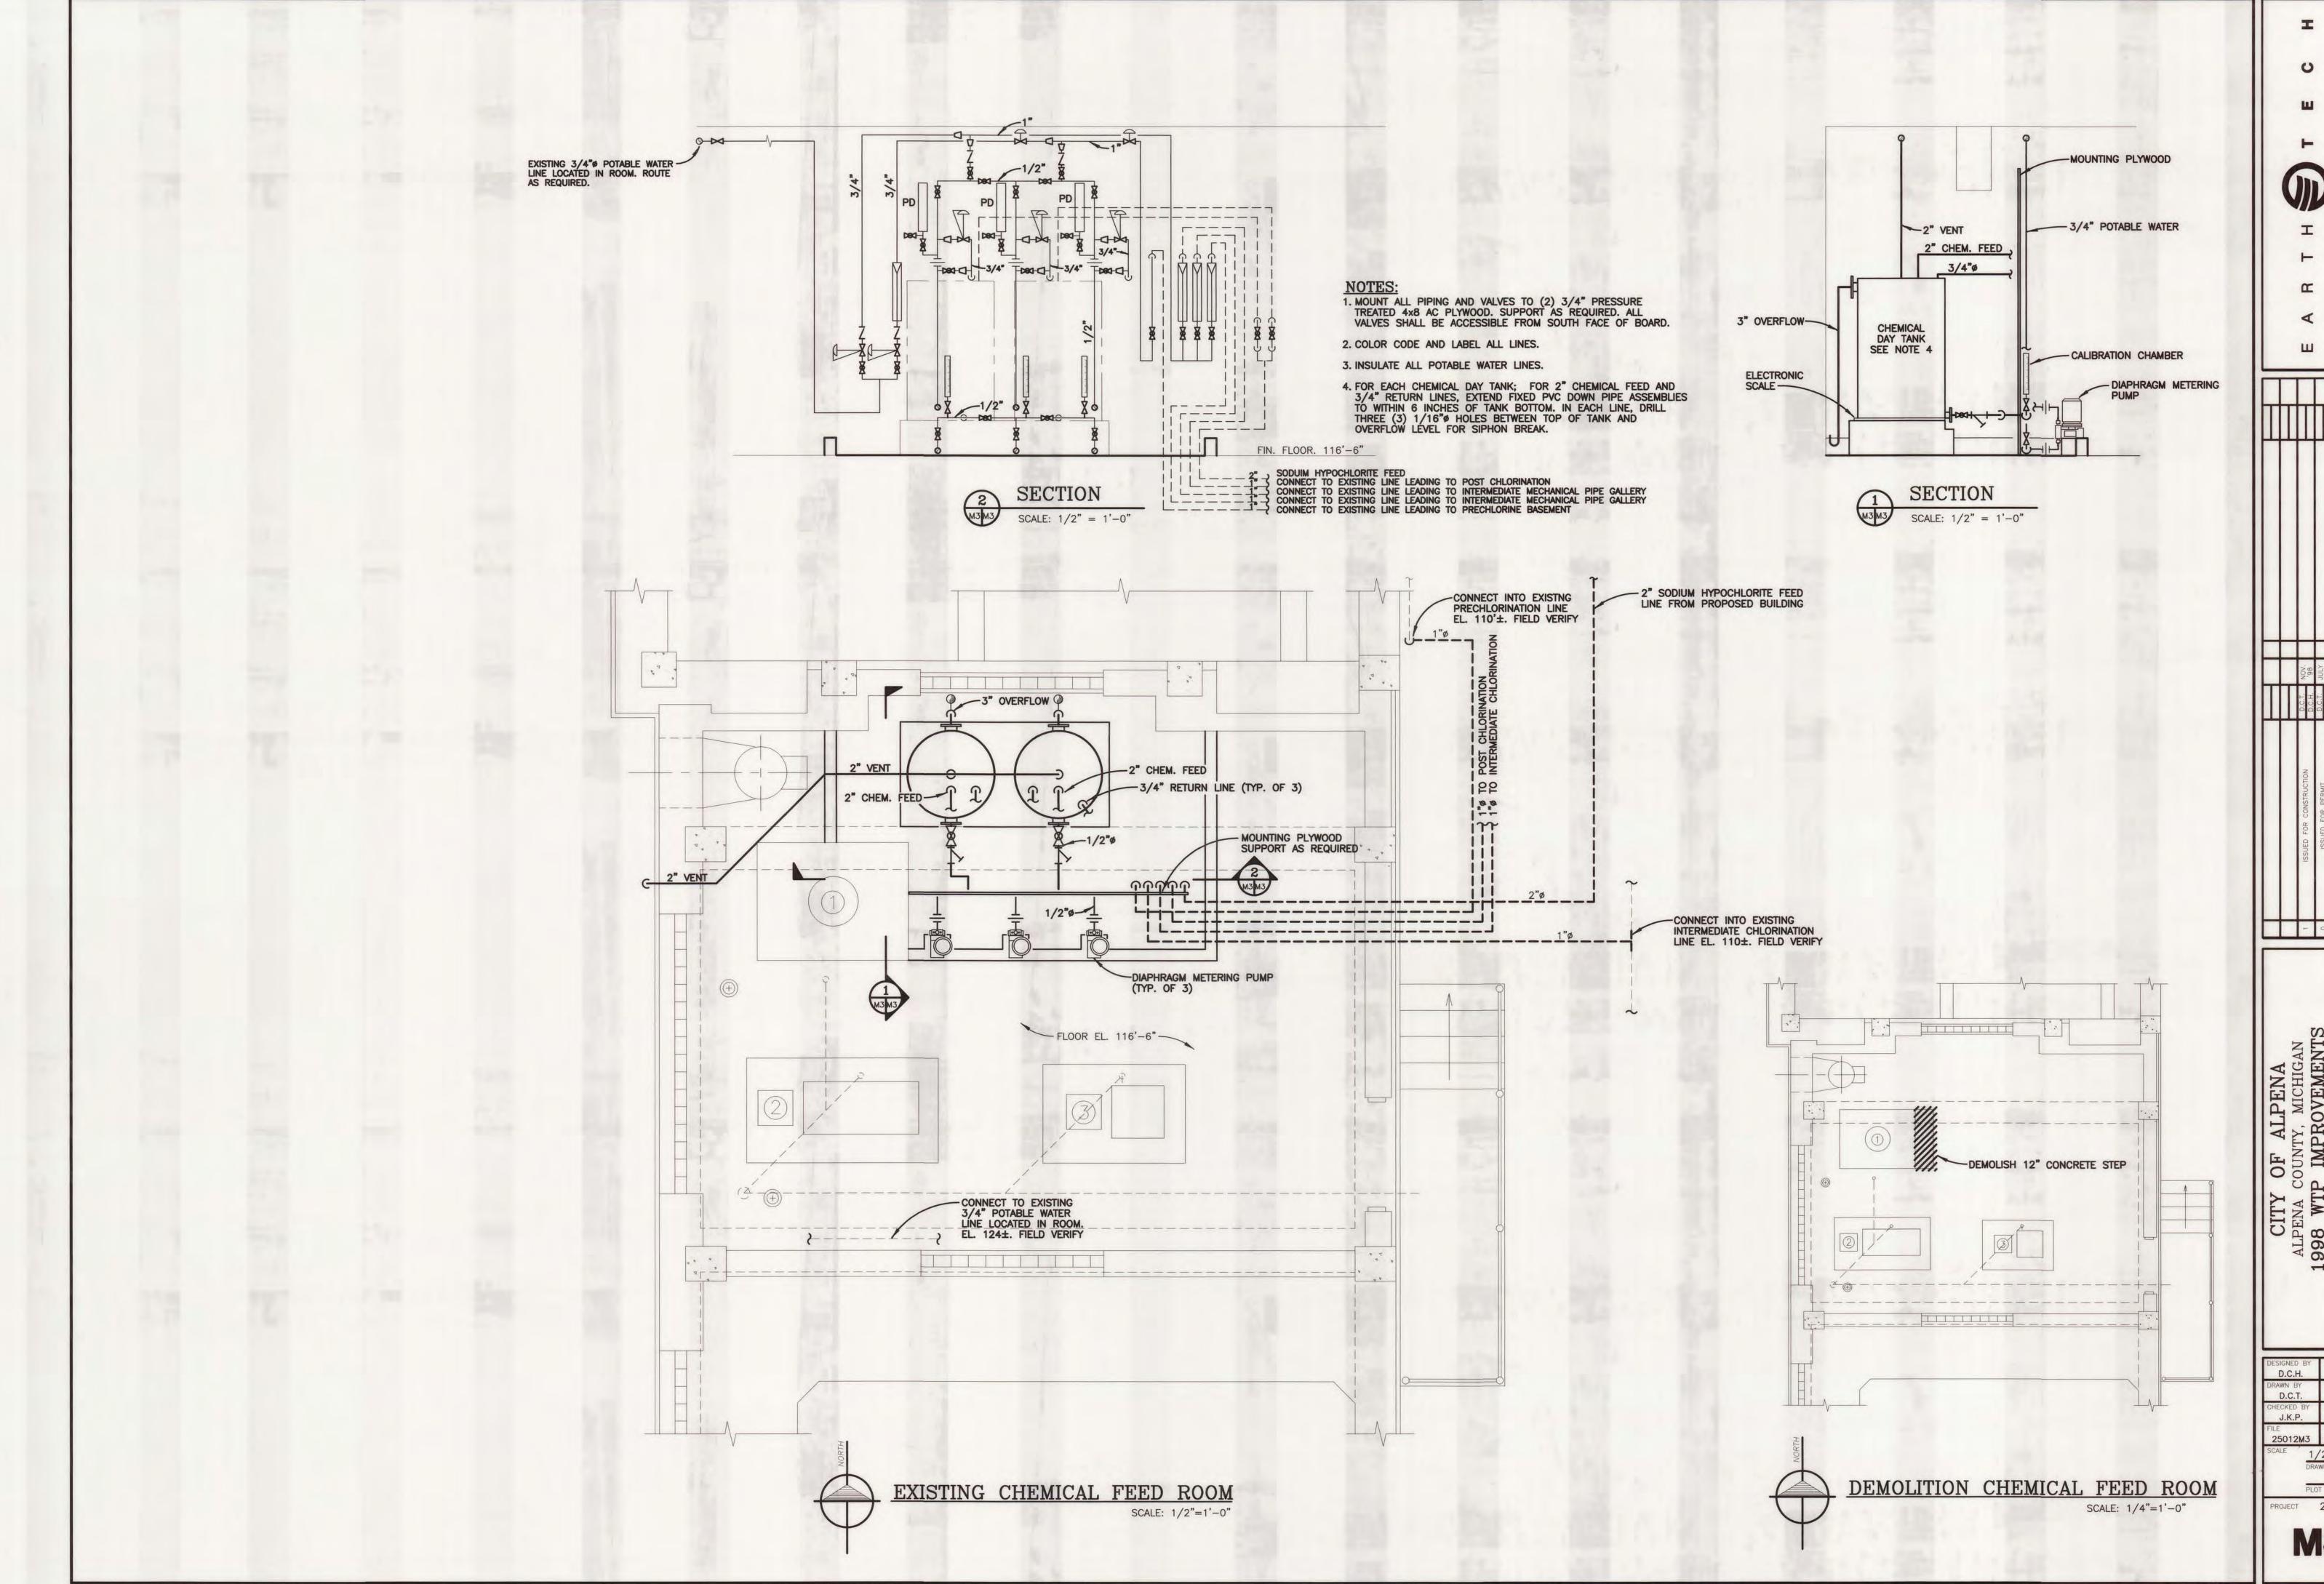1/2"=1'-0"
DRAWING
1:24
PLOT PROJECT 25012



LEGEND MOTORIZED DAMPER THERMOSTAT 5-1" NG -- NATURAL GAS PIPING, SCH 40 BLACK IRON BALL VALVE, 1/4 TURN, NATURAL GAS SERVICE

MARK	DESCRIPTION
L-1	RUSKIN COMBINATION LOUVER/DAMPER, MODEL ELC6375D, 96"x96", WITH 120V MOTORIZED DAMPER ACTUATOR, BIRD SCREEN, KYNAR FINISH, AND STANDARD CONSTRUCTION SEALS. 30.38 SF FREE AREA.
L-2&3	RUSKIN EPOXY COATED COMBINATION LOUVER/DAMPER, MODEL ELC63750 36"x24", WITH 120V MOTORIZED DAMPER ACTUATOR, BIRD SCREEN, KYNAR FINISH, AND STANDARD CONSTRUCTION SEALS. 2.21 SF FREE AREA, 1000 CFM INTAKE.
L-4	RUSKIN COMBINATION LOUVER/DAMPER, MODEL ELC6375D, 36"x16", WITH 120V/1/60 EXPLOSIONPROOF MOTORIZED DAMPER ACTUATOR, RUSKIN/SWARTOUT, SIEBE ENVIROMENTAL CONTROLS, MODEL MA6418, KYNAR FINISH, AND STANDARD CONSTRUCTION SEALS, BIRD SCREEN, 1.16 SF FREE AREA, 800 CFM INTAKE.
UH-1	REZNOR MODEL SFT-45, 45 MBH INPUT, 36 MBH OUTPUT, 39 FT THROW, 747 CFM, 1/16 HP MOTOR, 115/1/60, INCLUDE HANGER KIT AND VERTICAL INLET AIR/VENT TERMINAL KIT.
UH-2	REZNOR MODEL SCA-125, 125,000 BTUH INPUT, 100,000 BTUH OUTPUT 1400 CFM, 1/20 HP MOTOR, 115/1/60, 4.9 FLA, 245.0 WATTS, 5"ø VENT THRU ROOF. INCLUDE HANGER KIT AND VERTICAL INLET AIR/VENT TERMINAL KIT.
UH-3	REZNOR MODEL SCA-125, 125,000 BTUH INPUT, 100,000 BTUH OUTPUT 1400 CFM, 1/20 HP MOTOR, 115/1/60, 4.9 FLA, 245.0 WATTS, 5"Ø VENT THRU ROOF. INCLUDE S.S. HEAT EXCHANGER, HANGER KIT AND VERTICAL INLET AIR/VENT TERMINAL KIT.
UH-4	INDEECO MODEL 232-F17H-0109U COMPLETE WITH BUILT IN CONTROLS AND EXPLOSIONPROOF CONTROL PANEL (NEMA 9 ENCLOSURE), AND REMOTE EXPLOSIONPROOF THERMOSTAT MODEL C251-012, CEILING MOUNTING BRACKETS. FOR INSTALLATION IN A CLASS II, DIV 1, GROUP F, ATMOSPHERE. 10.0 kw CAPACITY, 460/3/60 . POWER CONNECTIONS TO BE A SINGLE 3 - WIRE CONNECTION TO THE HEATER.
UH-5	INDEECO MODEL 232-F04F-0087U COMPLETE WITH BUILT IN CONTROLS AND EXPLOSIONPROOF CONTROL PANEL (NEMA 9 ENCLOSURE), AND REMOTE EXPLOSIONPROOF THERMOSTAT MODEL C251-012, CEILING MOUNTING BRACKETS. FOR INSTALLATION IN A CLASS II, DIV 1, GROUP F, ATMOSPHERE. 7.5 kw CAPACITY, 460/3/60 . POWER CONNECTIONS TO BE A SINGLE 3 — WIRE CONNECTION TO THE HEATER.
EF-1	COOK MODEL 12SP15D, DIRECT DRIVE WALL MOUNT PROPELLER FAN. 0.125 ESP, 1000 CFM, 1/10 HP, 1250 RPM, 120V/1/60. FURNISH WITH BACK DRAFT DAMPER AND 1/2" MESH FAN SCREEN.
EF-2	COOK MODEL 12SP15D, DIRECT DRIVE EPOXY COATED WALL MOUNT PROPELLER FAN. 0.125 ESP, 1000 CFM, 1/10 HP, 1250 RPM, 120V/1/60. FURNISH WITH BACK DRAFT DAMPER AND 1/2" MESH FAN SCREEN.
EF-3	COOK MODEL 100W2B, 800 CFM AT 0.125 ESP, BELT DRIVE 1/6 HP MOTOR. WALL MOUNTED, FURNISH WITH MOTORIZED BACK DRAFT DAMPERS AND 1/2" MESH FAN SCREEN AT INLET. 120V/1/60 CLASS 1, GROUP D, EXPLOSIONPROOF MOTOR. EXPLOSIONPROOF THERMOSTAT MODEL C251-012.

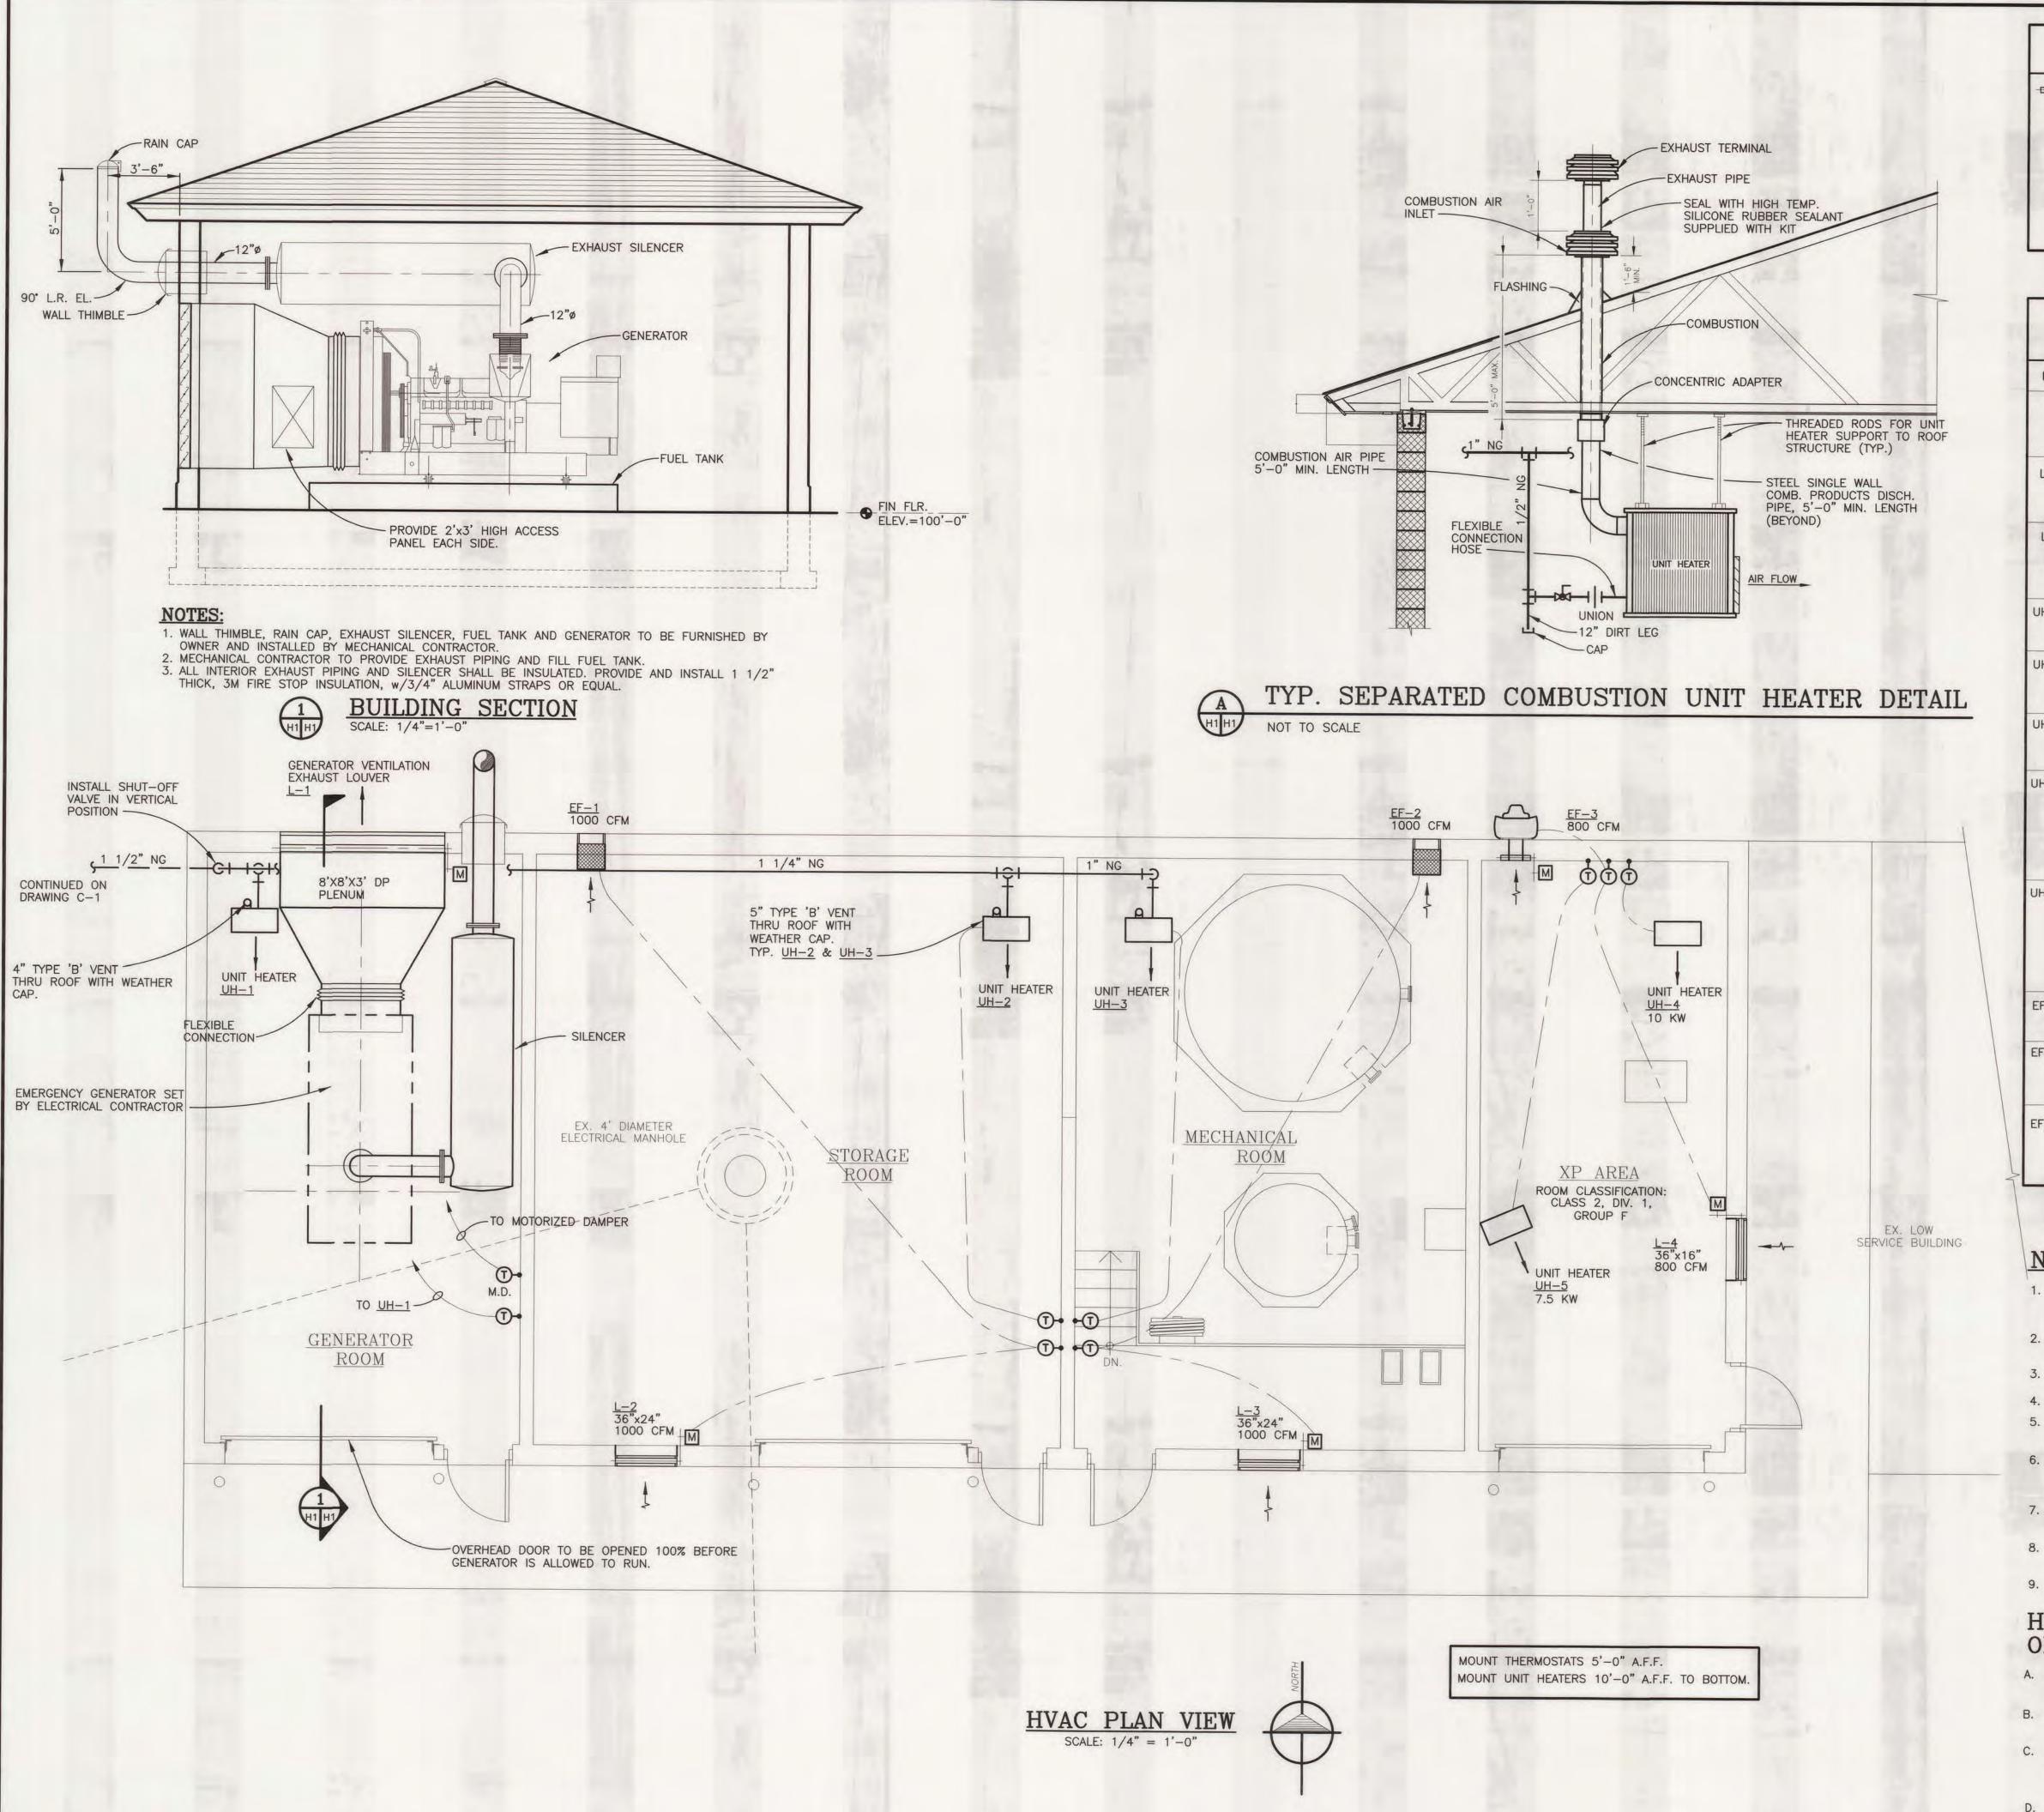NOTES:

- UNIT HEATER, INTAKE FAN, LOUVER/DAMPER ASSEMBLIES, DAMPER ACTUATOR MOTORS AND THERMOSTATS FURNISHED AND INSTALLED BY MECHANICAL
- 2. ALL EQUIPMENT AND CONTROLS IN NOTE 1 REQUIRING FIELD WIRING TO BE BY ELECTRICAL CONTRACTOR.
- 3. ALL POWER WIRING FURNISHED AND INSTALLED BY ELECTRICAL CONTRACTOR.
- 4. SEE ELECTRICAL DRAWINGS FOR CONTROL SCHEMATICS.
- 5. SEALING AND FLASHING OF ALL ROOF AND WALL PENETRATIONS BY MECHANICAL CONTRACTOR.
- 6. UNIT HEATER UH-3 & EXHAUST FAN EF-2 TO HAVE CORROSION RESISTANT T-STAT CHROMALOX MODEL WCRT-100, FOR MODERATELY CORROSIVE CONDITIONS. 120V/1/60HZ THERMOSTAT, FIELD WIRED BY ELECTRICAL CONTRACTOR.
- CONTRACTOR TO SUBMIT LOUVER COLOR SAMPLES TO OWNER PRIOR TO PURCHASE AND INSTALLATION.
- 8. IN GENERATOR ROOM, MAINTAIN 2'-0" MIN. CLEARANCE BETWEEN GENERATOR EXHAUST PIPE AND GAS LINES.
- 9. INSTALL ALL EQUIPMENT PER MANUFACTURERS RECOMMENDATIONS.

HEATING & VENTILATION SEQUENCE OF OPERATIONS:

- A. UNIT HEATER UH-1, UH-2, UH-4 & UH-5 CYCLES AS REQUIRED TO SATISFY THE RESPECTIVE HEATING ONLY THERMOSTAT. (SET POINT 60°F, ADJUSTABLE.).
- B. UNIT HEATER UH-3 CYCLES AS REQUIRED TO SATISFY THE HEATING ONLY THERMOSTAT T (SETPOINT 70°F, ADJUSTABLE.).
- C. EXHAUST FANS EF-1, EF-2, EF-3 AND LOUVER/DAMPER L-1 CYCLES AS REQUIRED TO SATISFY THE RESPECTIVE VENTILATION THERMOSTAT (SET POINT 90°) ALL UNITS TO OPERATE WITH MANUAL OVERRIDE WALL SWITCH.
- BEFORE EMERGENCY GENERATOR SET IS ENERGIZED LOUVER L-1 AND OVERHEAD DOOR IS FULLY OPENED.
- E. SEE ELECTRICAL DRAWINGS FOR CONTROL WIRING DIAGRAMS.

CITY OF ALPENA
ALPENA COUNTY, MICHIGAN
1998 WTP IMPROVEMENTS
CHEMICAL AND STORAGE BLDG.
HVAC PLAN

1/4"=1'-0' 1:48

ROJECT 25012

11

GENERAL INSTRUMENT OR FUNCTION SYMBOLS

	PRIMARY LOCATION NORMALLY ACCESSIBLE TO OPERATOR	PRIMARY LOCATION NORMALLY INACCESSIBLE OR BEHIND PANEL	FIELD MOUNTED	AUXILIARY LOCATION NORMALLY ACCESSIBLE TO OPERATOR
DISCRETE INSTRUMENTS	Θ	Θ		Θ
SHARED DISPLAY, SHARED CONTROL		9		
COMPUTER FUNCTION	\hookrightarrow	\hookrightarrow		\Leftrightarrow
PROGRAMMABLE LOGIC CONTROL				

MEANINGS OF IDENTIFICATION LETTERS

	FIRST	LETTER	SUCCEEDING LETTERS					
	MEASURED OR INITIATING VARIABLE	MODIFIER	READOUT OR PASSIVE FUNCTION	OUTPUT FUNCTION	MODIFIER			
4	ANALYSIS		ALARM					
3	BURNER FLAME		USER'S CHOICE	USER'S CHOICE	USER'S CHOICE			
	CONDUCTIVITY	103.5	60.00	CONTROL				
)	DENSITY (MASS) OR SPECIFIC GRAVITY	DIFFERENTIAL						
	VOLTAGE (EMF)		PRIMARY ELEMENT					
	FLOW RATE	RATIO (FRACTION)	99.3					
3	GAGING (DIM.)		GLASS					
4	HAND (MANUALLY INITIATED)				HIGH			
	CURRENT	9758	INDICATE					
j	POWER	SCAN						
<	TIME OR TIME SCHEDULE	829	100 - 10	CONTROL STATION				
	LEVEL	100	LIGHT (PILOT)		LOW			
И	MOISTURE OR HUMIDITY	. 603			MIDDLE OR INTERMEDIATE			
١	USER'S CHOICE		USER'S CHOICE	USER'S CHOICE	USER'S CHOICE			
)	USER'S CHOICE	7.00	ORIFICE (RESTRICTION)					
0	PRESSURE OR VACUUM		POINT (TEST CONNECTION)					
Q	QUANTITY OR EVENT	INTEGRATE OR TOTALIZE	113					
?	RADIOACTIVITY	10.00	RECORD OR PRINT					
S	SPEED OR FREQUENCY	SAFETY	0.1	SWITCH				
Г	TEMPERATURE	100	101	TRANSMIT	2.3			
J	MULTIVARIABLE		MULTIFUNCTION	MULTIFUNCTION	MULTIFUNCTION			
V	VISCOSITY			VALVE, DAMPER OR LOUVER				
N	WEIGHT OR FORCE	21/1	WELL					
<	UNCLASSIFIED		UNCLASSIFIED	UNCLASSIFIED	UNCLASSIFIED			
Y	USER'S CHOICE		100 100	RELAY OR COMPUTE	1 100			
Z	POSITION			DRIVE, ACTUATE OR UNCLASSIFIED FINAL ELEMENT				

P & ID ABBREVIATIONS

AS - AIR SUPPLY

IA - INSTRUMENT AIR ES - ELECTRIC SUPPLY

HS - HYDRAULIC SUPPLY

N2 - NITROGEN SUPPLY WS - WATER SUPPLY STM75 - STEAM SUPPLY-PRESSURE

LINE DESIGNATION 5111115 AIR TUBING CAPILLARY SXXXS ELECTRICAL 5--5 PROCESS CONNECTION

HYDRAULIC SIGNAL S L LS

OR SUPPLY

ELECTROMAGNETIC OR SONIC SIGNAL (GUIDED) ELECTROMAGNETIC OR SONIC SIGNAL (NOT GUIDED) INTERNAL SYSTEM LINK (SOFTWARE OR DATA LINK)

MECHANICAL LINK

5005 ~ ~

5 • 5

25012E1 NONE PROJECT 25012

OF ALPENA
COUNTY, MICHIGAN
IMPROVEMENT

CITY (ALPENA CO

LEGEND


ELECTRICAL


JUN. '98

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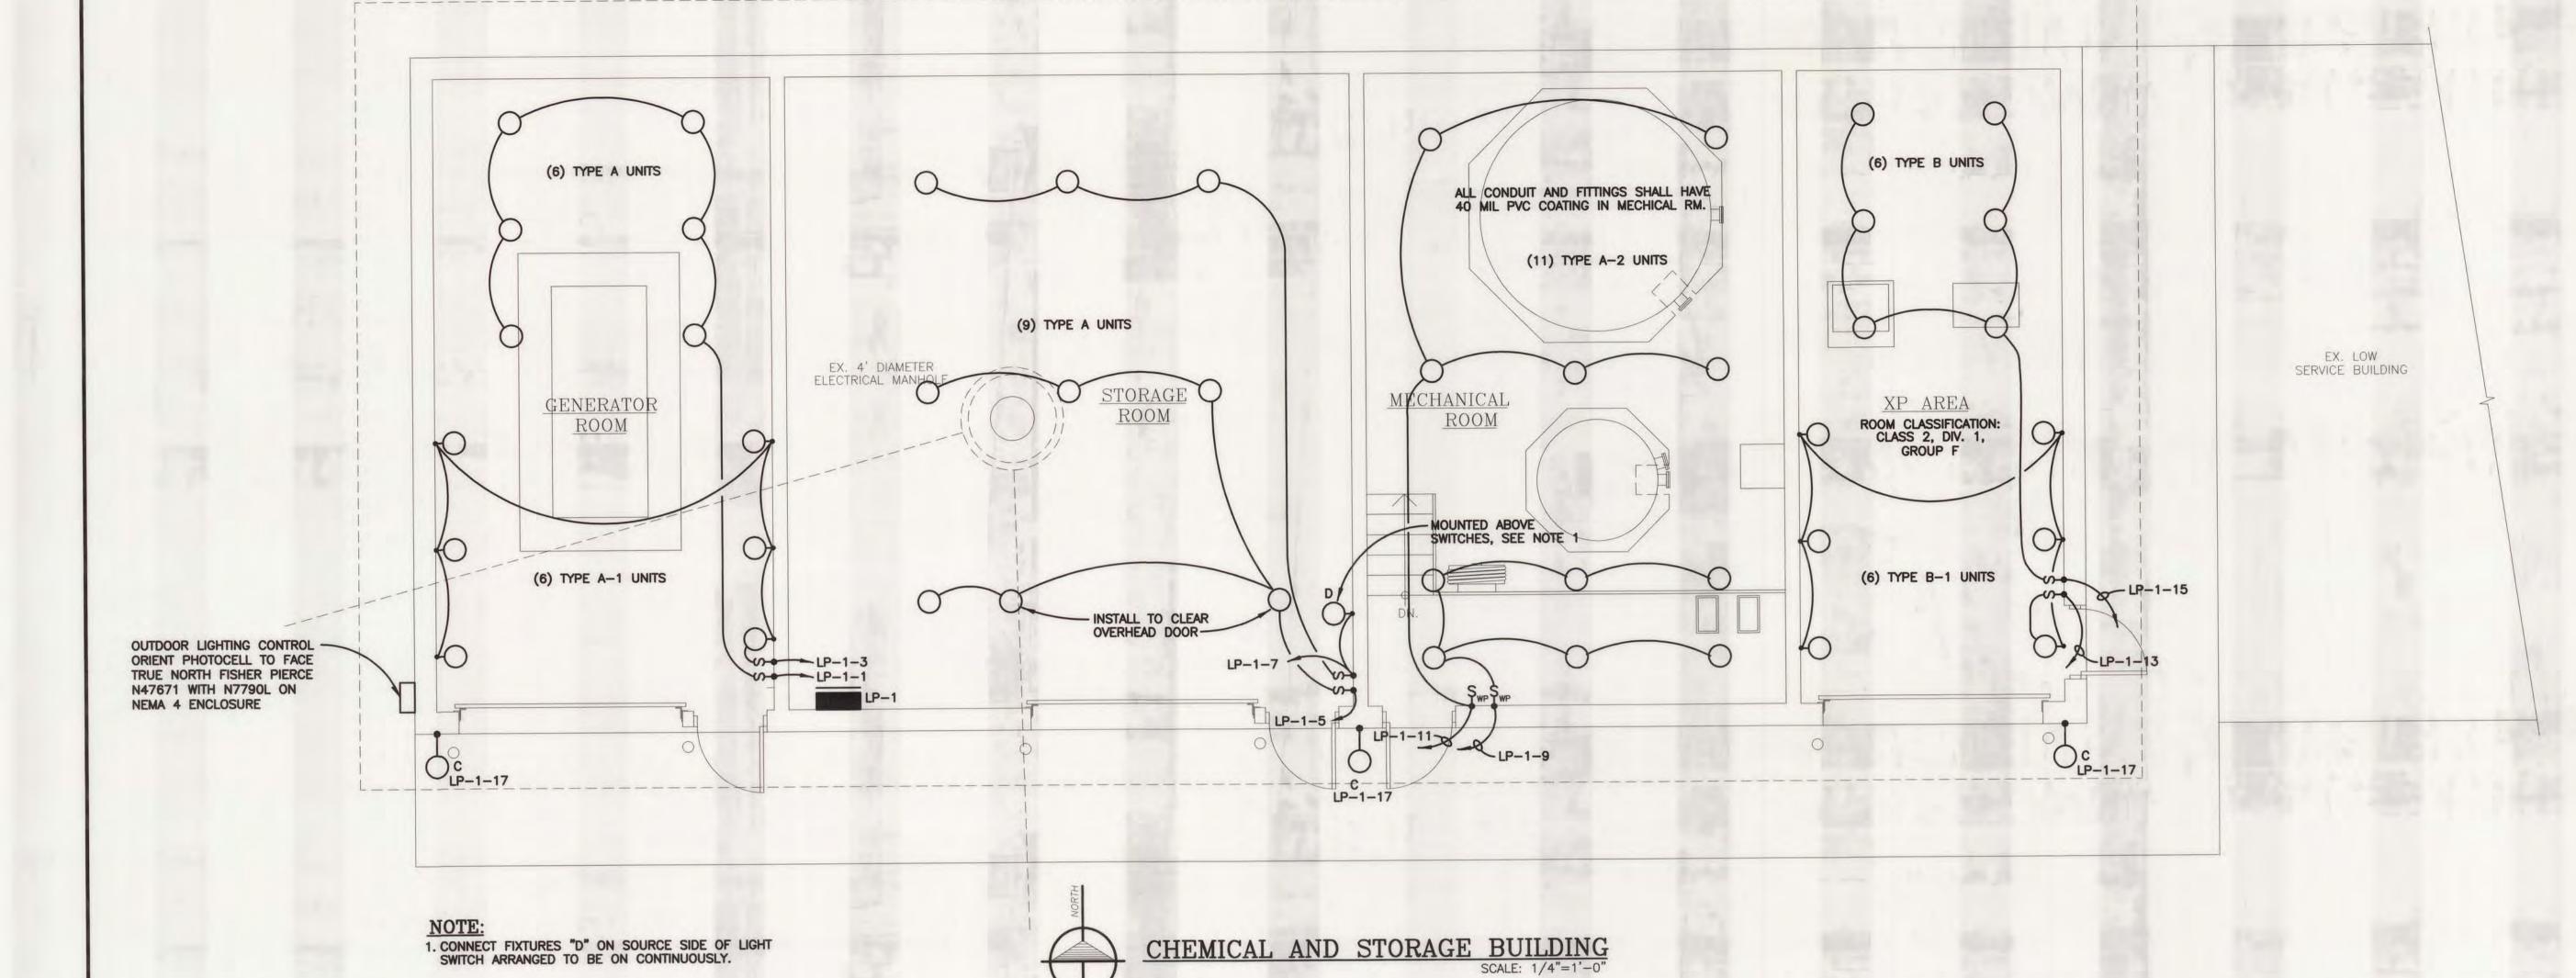


CITY OF ALPENA
ALPENA COUNTY, MICHIGAN
1998 WTP IMPROVEMENTS
CHEMICAL AND STORAGE BUILDING
ELECTRICAL PLAN

1/4"=1'-0" 1:48

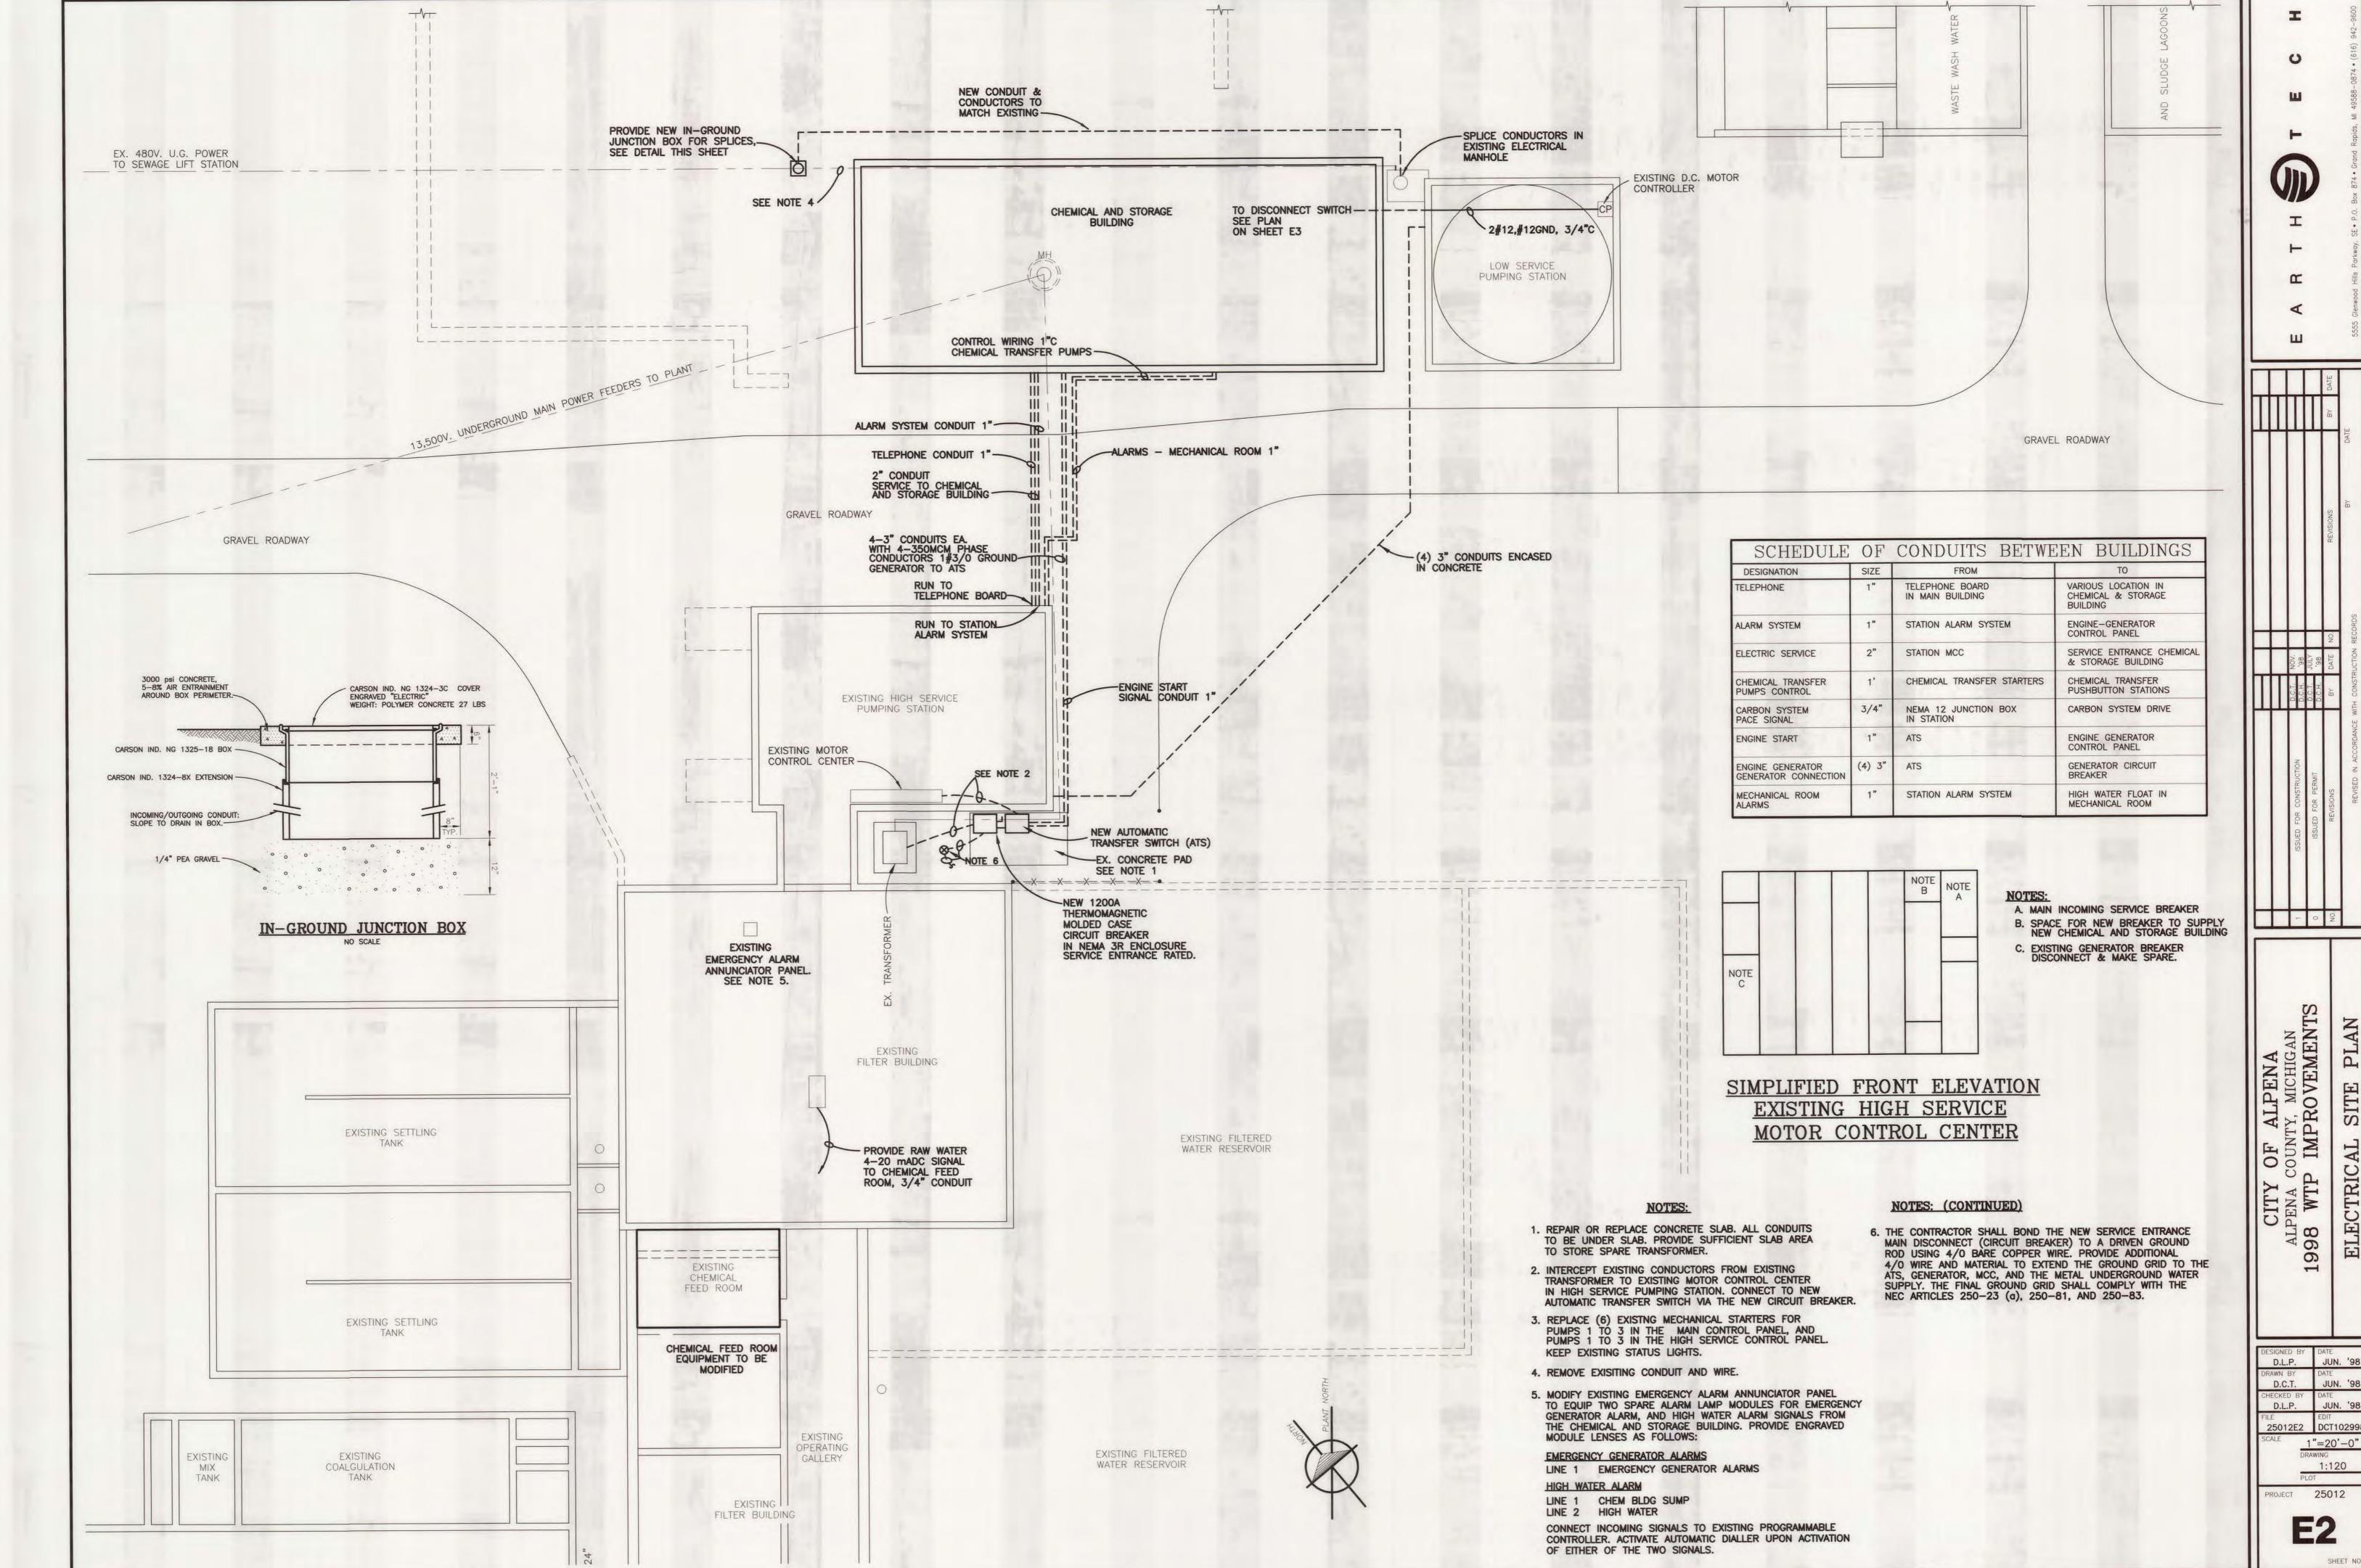ROJECT 25012

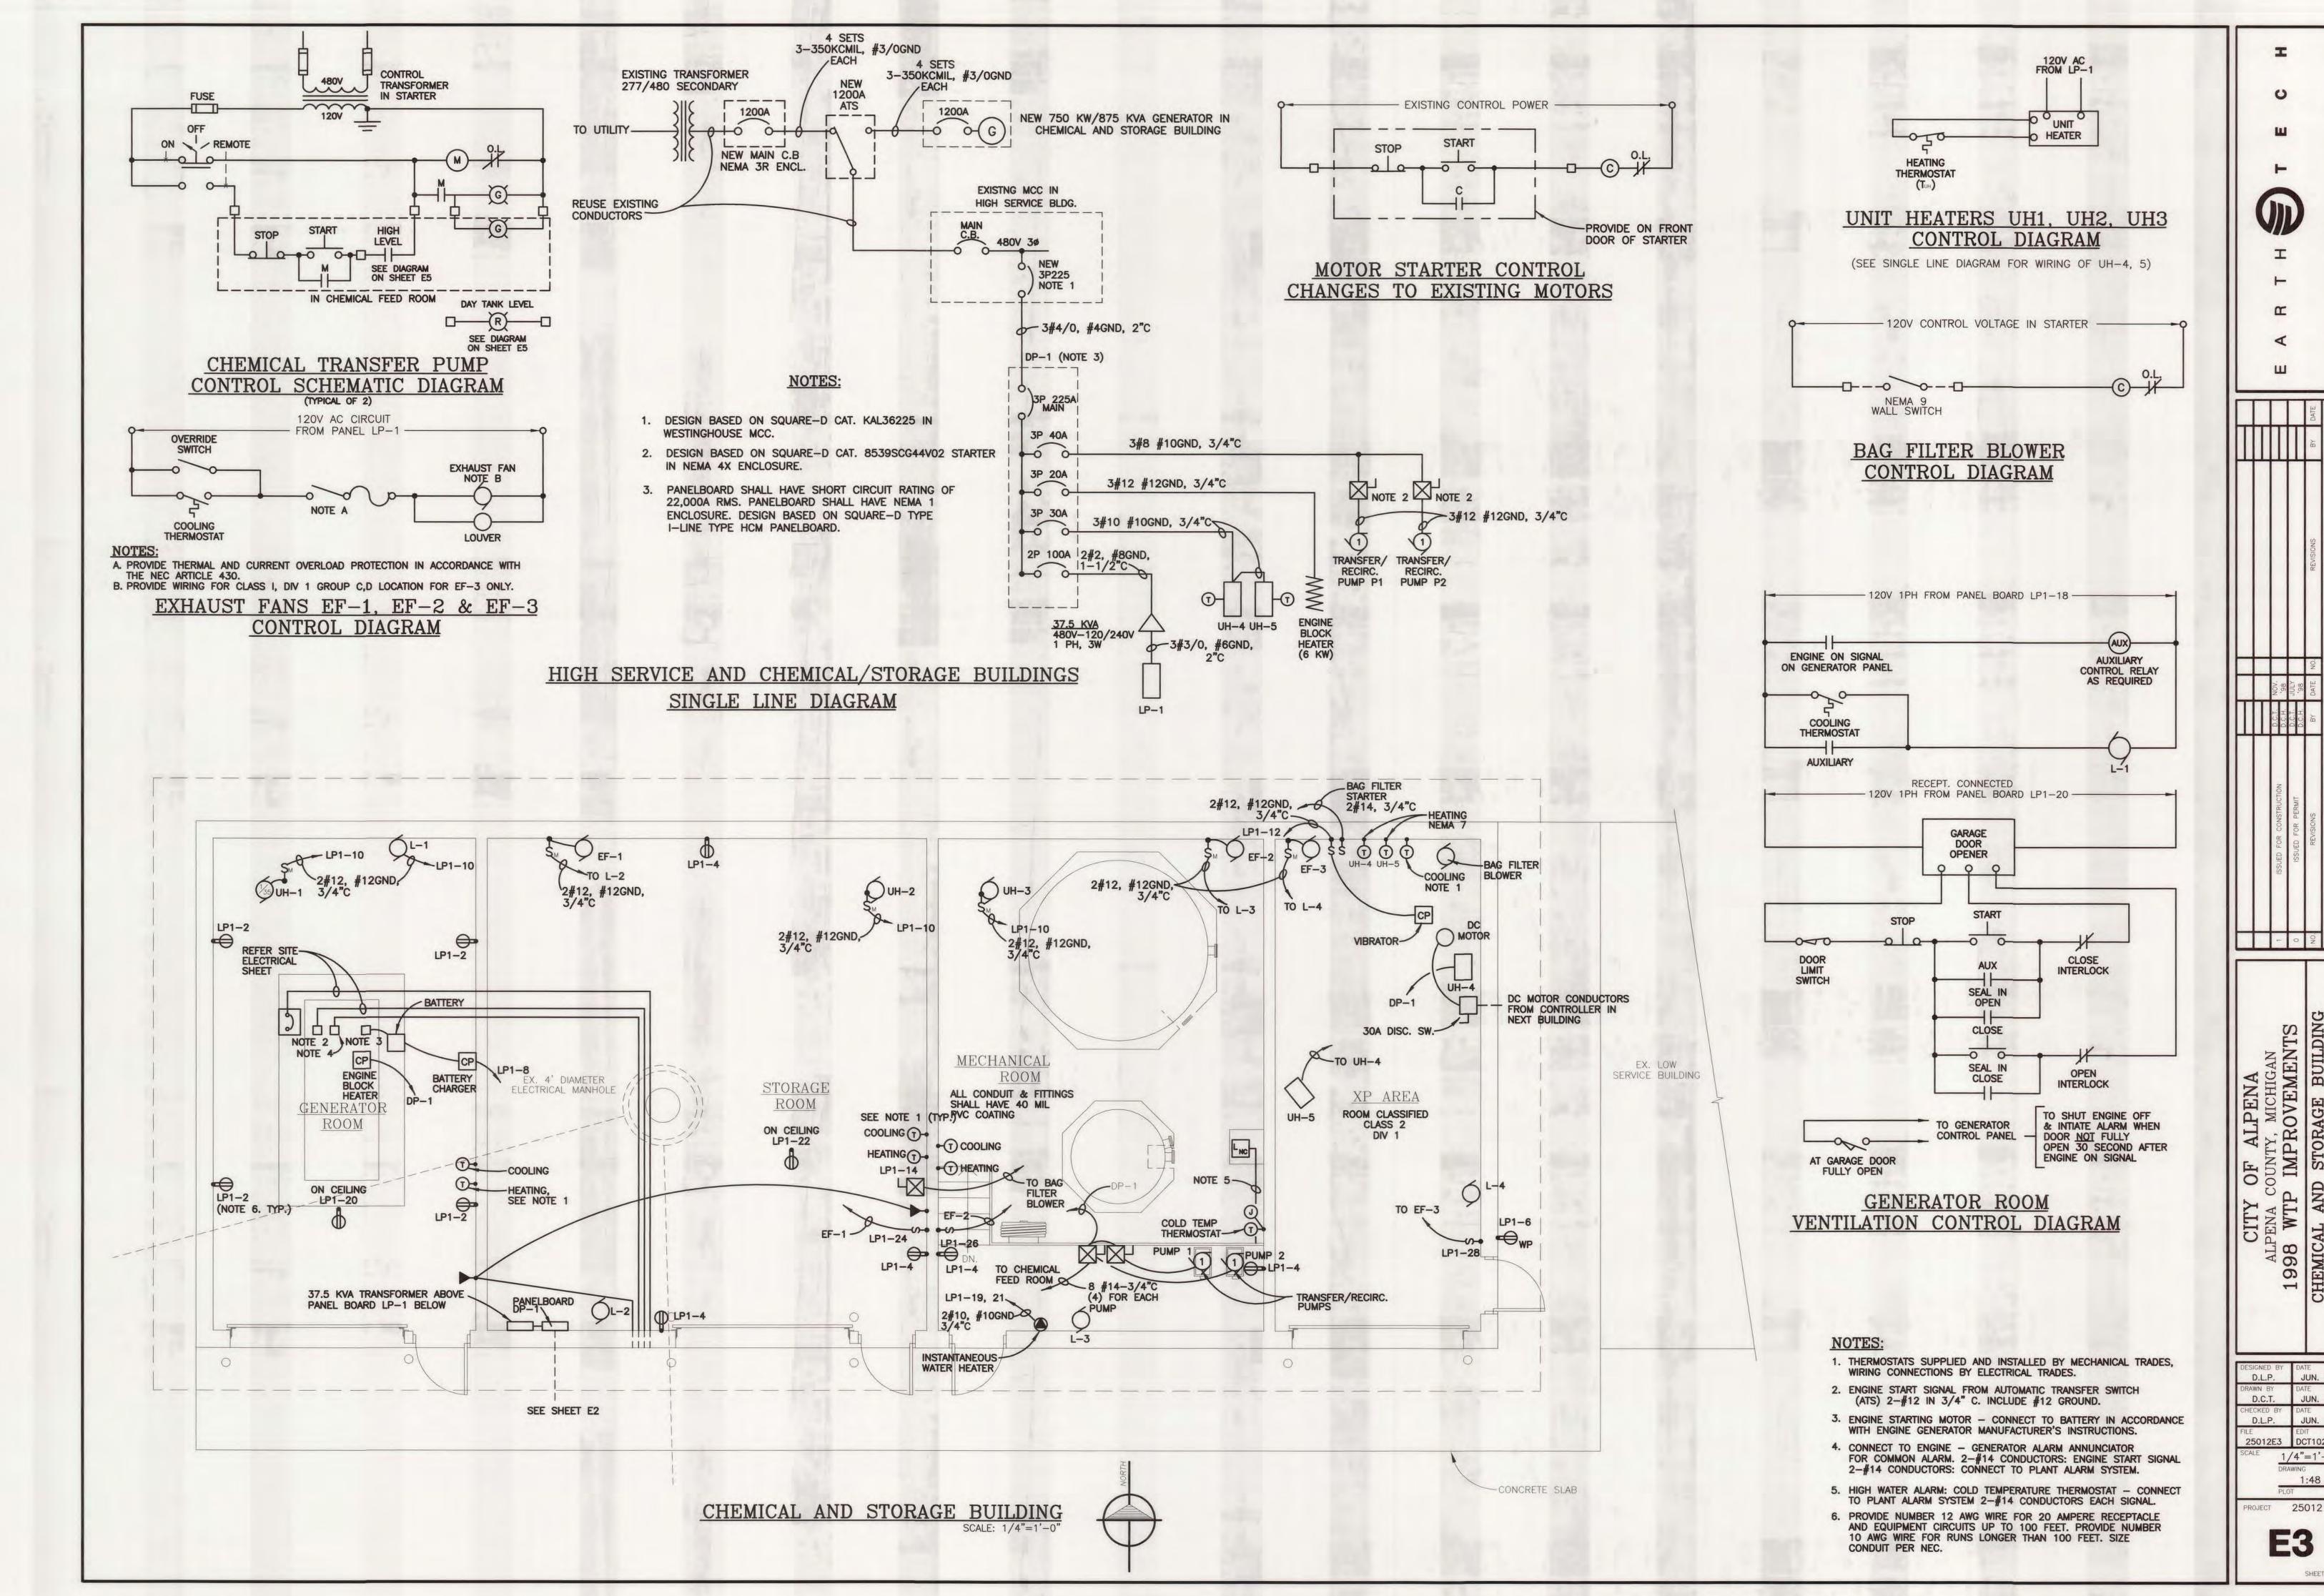



		1000000		114			NEMA 1	VOLT	AMD		-	DUTLETS	2		CIRC	TILIT	
	CIRC				DUTLETS		DESCRIPTION		AMP.	DESCRIPTION		REC.		VA		AMPS	NC
NO.	AMPS	POLES		LTS.	REC.	OTHER		ØA 2600		RECEPTACLE, GENERATOR ROOM	LIO.	4	OTTIER	800	1	20	2
1	20	1	1800	6			GENERATOR ROOM LIGHTS	2600		RECEPTACLE, STORAGE, MECH. RM		5		1000	1	20	4
3	20	1	1800	6			GENERATOR ROOM LIGHTS	2000		RECEPTACLE, CARBON ROOM		1		200	1	20	6
5	20	1	1800	6			STORAGE ROOM LIGHTS	2000		BATTERY CHARGER			1	1200	1	20	8
7	20	1	950	4			STORAGE ROOM LIGHTS	2100		UH 1,2,3			3	300	1	20	10
9	20	1	1800	6			MECH. ROOM LIGHTS, PLATFORM	2100		CARBON FEED VIBRATOR			1	230	1	20	12
11	20	1	1500	5			MECH. ROOM LIGHTS, LOWER	3400	200	CARBON BAG FILTER BLOWER			1	1600	1	20	14
13	20	1	1800	6			CARBON ROOM LIGHTS	3400						1000		_	1
15	20	1	1800	6			CARBON ROOM LIGHTS	640	1800	LOUVER L-1				960	1	20	1
17	20	1	540	3		WATER	OUTDOOR LIGHTS	640	7750	RECEPTACLE, DOOR OPENER GEN. RM.	-		_	1000	1	20	2
19	30	2	2750			HEATER	INSTANT WATER HEATER	7750		RECEPTACLE, DOOR OPENER STOR. RM.				1000	1	20	2
21	-	-	2750				-	3750		EF-1 & L-2			2	300	1	20	2
23	20						SPARE	700	300	EF-2 & L-3			2	300	1	20	2
25	20						SPARE	300	000				2	600	1	20	2
27	20						SPARE		600	EF-3 & L-4			2	000	'		3
29	20						SPARE			SPARE		-				20	3
31	20						SPARE			SPARE						20	3
33	20						SPARE			SPARE						20	3
35	20						SPARE	-		SPARE						20	- 10
37	20						SPARE			SPARE						20	3
39	20	4					SPARE			SPARE						20	4
41	20						SPARE			SPARE						20	4

		TOTAL	L	AMP	MOUNTING
TYPE	DESCRIPTION	W	W	TYPE	MOUNTING
A	APPLETON V-51 ENCLOSED & GASKETED INCANDESCENT CAT #VXHA2050G WITH PORCELAIN ENAMEL REFLECTOR OR EQUAL CROUSE HINDS	300	300	INC PS-300 MED	IMMEDIATELY BELOW RAFTERS. PROVIDE AUX MOUNTING AS NECESSARY.
A-1	SIMILAR TO UNIT A EXCEPT FOR WALL MOUNTING. APPLETON JBW20G	300	300	PS-300 MED	11'-0" A.F.F.
A-2	SAME AS A EXCEPT COAT ALL EXPOSED METAL PARTS w/40 MIL PVC	300	300	INC PS-300 MED	IMMEDIATELY BELOW RAFTERS. PROVIDE AUX MOUNTING AS NECESSARY.
В	APPLETON A-51 INCANDESCENT EXPLOSION PROOF CAT #AC2050 WITH PORCELAIN ENAMEL OR EQUAL CROUSE HINDS	300	300	INC PS-300 MED	ON CEILING
B-1	SIMILAR TO UNIT B EXCEPT FOR WALL MOUNTING. APPLETON ALB-1050, LONG BRACKET	300	300	INC PS-300 MED	11'-0" A.F.F.
С	APPLETON WALLMASTER HIGH PRESSURE SODIUM WALL MOUNT FIXTURE CAT #G-WM334L-12RH	126	100	HPS	13'-0" ABOVE FOUNDATION
D	APPLETON MERCMASTER ENCLOSED AND GASKETED, WALL MOUNTED APPLETON MLWL352G1N1	50	35	HPS 35W	8'-0" A.F.F.

E A R T H OT E C


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ISSUED FOR CONSTRUCTION	D.C.T. NOV.				Ц
ISSUED FOR PERMIT	D.C.T. JULY D.C.H. '98				
REVISIONS	BY DATE	NO.	REVISIONS	BY	DATE
Table 1	Ottoriotto	000000000000000000000000000000000000000	BY	DATE	
REVISED IN ACCORDANCE WITH CONSTRUCTION RECURDS	CONSTRUCTIO	N RECORDS			

ALPENA COUNTY, MICHIGAN
1998 WTP IMPROVEMENTS
CHEMICAL AND STORAGE BUILDIN

D.L.P.	JUN. '98
D.C.T.	JUN. '98
D.L.P.	JUN. '98
5012E4	DCT102998
1/	/4"=1'-0"
DRA	1:48
PLO	T

PROJECT 25012

E4

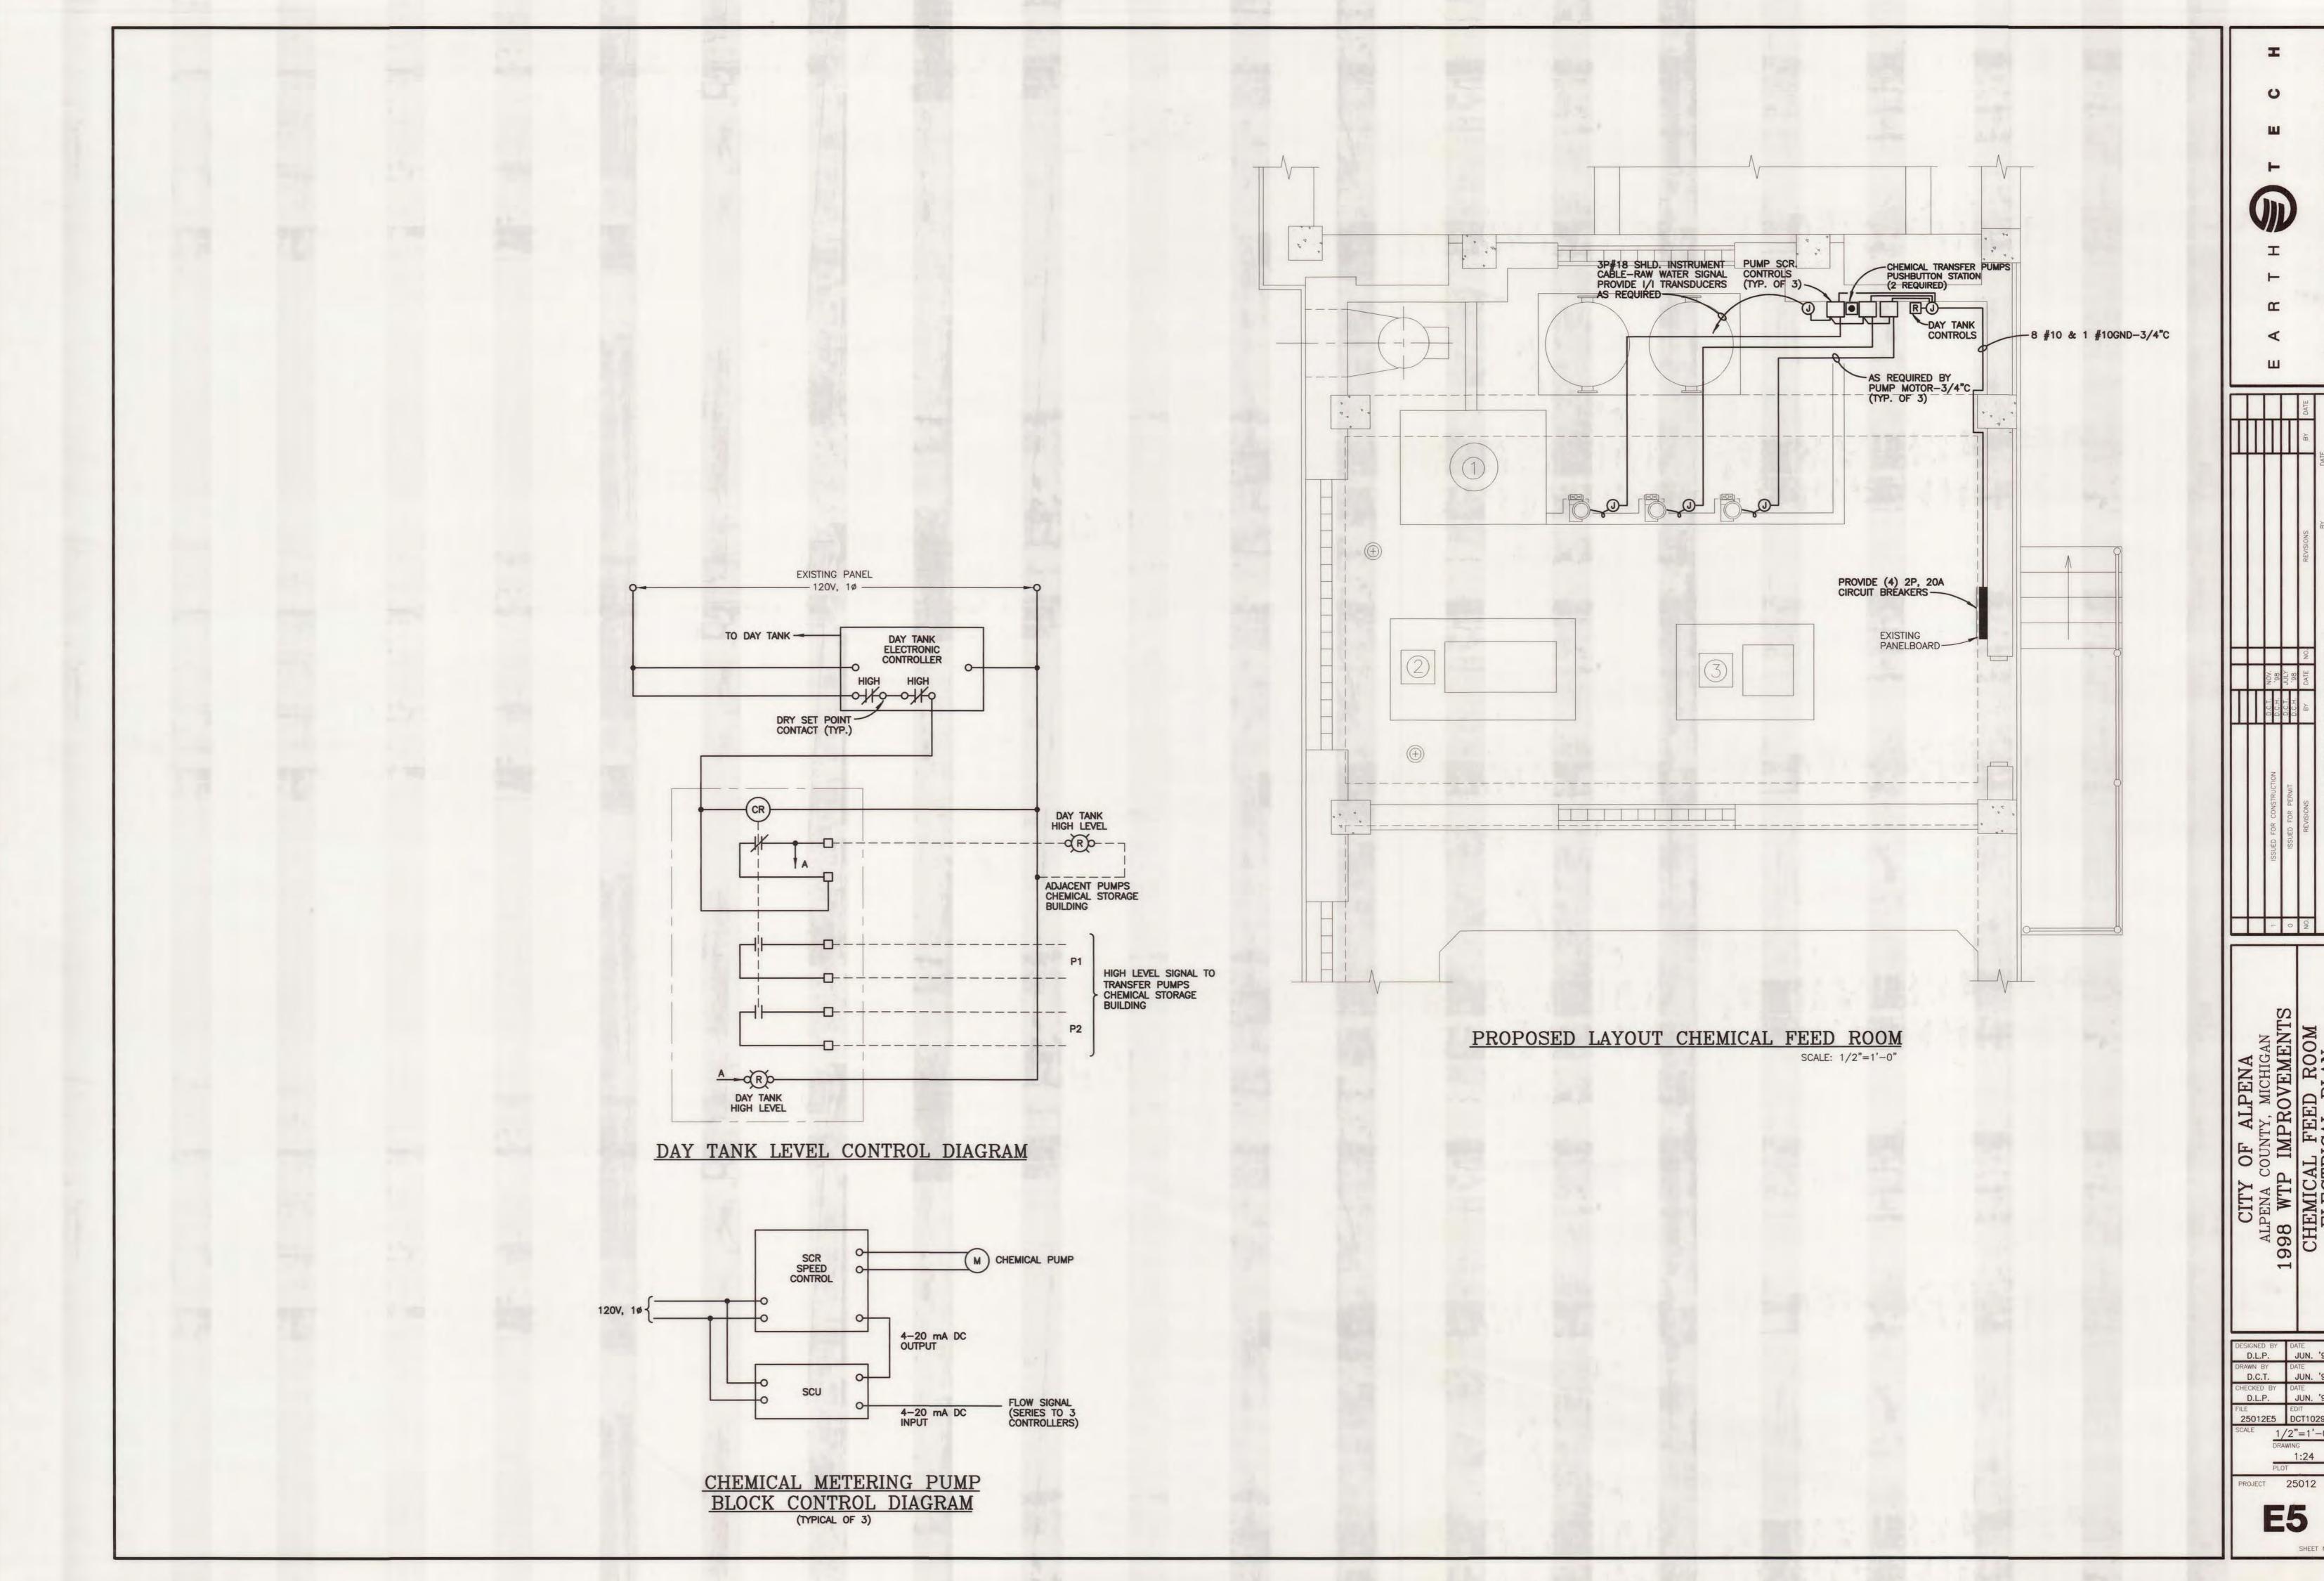

1/2"=1'-0"
DRAWING
1:24
PLOT